	PLUMBI	NG LEGEND
SYMBOL	ABBREV.	DESCRIPTION
	CW	COLD WATER LINE
	HW	HOT WATER LINE
	HWR	HOT WATER RETURN
R0	RO	R.O. (REVERES OSMOSIS) COLD WATER LINE
G	G	GAS LINE
	_ V	VENT LINE
	S or W	SOIL OR WASTE BELOW FLR OR GRADE
	S or W DS	SOIL OR WASTE - SUSPENDED
DS		DOWNSPOUT
OD	OD SD	OVERFLOW DRAIN STORM DRAIN BELOW FLR OR GRADE
	F	AUTO FIRE SPRINKLER (N.I.P.C.)
⊠ o⇒+	GV/SOV	GATE VALVE / SHUT OFF VALVE
и	CV	CHECK VALVE
cw	CWV	COMBINATION WASTE AND VENT
⊠	FS	FLOOR SINK
(B) (C)	FD OR AD	FLOOR OR AREA DRAIN
◎ •	RD OR OD	ROOF OR OVERFLOW DRAIN
ф	FC0	FLOOR CLEANOUT
I	wco/cco	WALL CLEANOUT/CEILING CLEANOUT
-	HB	HOSE BIB
+-	WH	WALL HYDRANT
	<u> </u>	UNION
	D	DRAIN COURT OFF DOCK
<u> </u>	PC/SOC	PLUG COCK / SHUT-OFF COCK
SR	SR A.P.	SUD RELIEF ACCESS PANEL
	BEL.	BELOW
	ABV.	ABOVE
	DN.	DOWN
	CLG.	CEILING
	<u>C.I.</u>	CAST IRON
	CONC.	CONCRETE
	CONN.	CONNECT
	DWG. FIN. FLR.	DRAWING FINESTER OF THE PROPERTY OF THE PROPER
		FINISHED FLOOR
	FLR.	FLOOR
	F.U.	FIXTURE UNIT
	G.P.M.	GALLONS PER MINUTE
	HDR.	HEADER
	HTR.	HEATER SUATION
	I.E.	INVERT ELEVATION
	N.I.P.C.	NOT IN PLUMBING CONTRACT
	P.O.C. 💠	POINT OF CONNECTION
ļ	P.R.V.	PRESSURE REDUCING VALVE
	REQ'D	REQUIRED
	V.T.R.	VENT THRU ROOF
	B.F.P.	BACKFLOW PREVENTER
	RP	REDUCED PRESSURE B.F.P.
	P.V.C.	POLYVINYLCHLORIDE
	RECT.	RECTANGULAR
	REQ'D	REQUIRED
	V.T.R.	VENT THRU ROOF
	Y.B.	YARD BOX
	IND	INDIRECT
	(N)	NEW
	(R)	RELOCATED
	EXIST. (E)	EXISTING
	WM	WATER METER
	GM ,	GAS METER
	ESV	EARTHQUAKE SHUT-OFF VALVE

SERVICE - WATER HEATING NOTES

1. INSULATION OF DOMESTIC HOT WATER PIPING SHALL BE IN ACCORDANCE WITH 2019 CPC SECTION 609.11, AND SECTION 120.3, TABLE 120.3—A OF THE 2019 BUILDING ENERGY EFFICIENCY STANDARDS WHICHEVER IS LARGER.

NOTES

- 1. ALL HOT WATER PIPE TO BE INSULATED WITH SNAP-ON TYPE FIBERGLAS INSULATION WITH STAPLED CANVAS JACKETS.
- 2. THE THICKNESS OF INSULATION LISTED ABOVE IS BASED ON MATERIALS HAVING A THERMAL RESISTANCE IN THE RANGE OF R-7.7 TO R-12.5 PER INCH. ADJUSTMENTS ARE REQUIRED FOR INSULATION MATERIALS OUTSIDE THIS RANGE.

ACOUSTICAL NOTES

- 1. ALL OF THE PLUMBING SYSTEM MUST BE ISOLATED FROM THE BUILDING FRAMEWORK.
- FOR ½" TO 2" DIAMETER PIPES, USE HOLDRITE ACOUSTIPLUMB ISOLATOR.
 FOR PIPING GREATER THAN 2" DIAMETER, FELT WRAP ALL PIPING WHERE
 IT IS IN DIRECT CONTACT WITH STRUCTURE. NO PIPING SHALL TOUCH
 STRUCTURE WITHOUT FELT WRAP.
- 2. THE ELBOWS BELOW TOILET AND TUB WASTE OUTLETS SHALL BE ISOLATED FROM ALL POSITIONING BLOCKS USING CARPET PADDING OR HIGH DENSITY 1/2"THICK FELT MATERIAL. THE ENTIRE FRAMING CAVITY SURROUNDING THESE ELBOWS SHALL BE COMPLETELY PACKED WITH FIBERGLASS, OPEN FACED MINERAL WOOL OR SPRAY—ON ADHESIVE CELLULOSE INSULATION MATERIALS.

NOTIFY WATER CO. OF PROPOSED NEW SERVICES TO EXISTING MAINS, AND PAY COST FOR METERS AND HOOKUP INSTALLATIONS.

- 2. SLOPE ALL SOIL & WASTE LINES MIN. 2% SLOPE (1/4" PER FT.) UNLESS OTHERWISE INDICATED.
- 3. DRAWINGS ARE DIAGRAMMATIC. DO NOT SCALE PLUMBING
- PLANS FOR EXACT HORIZONTAL LOCATION OF PIPE RUNS.

 4. SUPPLY ROUGH—IN, INSTALL AND CONNECT PLUMBING
- FIXTURES AS REQUIRED UNLESS OTHERWISE NOTED.
- 5. PROVIDE AND INSTALL AN AUTOMATIC AIR VENT AT HIGH POINT OF ALL HOT WATER LINES.
- 6. VERIFY & COORDINATE ROUGH—IN AND FIXTURE LOCATIONS WITH MECHANICAL DWGS. ARCHITECTURAL DWGS. PRIOR TO FABRICATION OR INSTALLATION OF MATERIALS AND AGAIN PRIOR TO SLAB POUR.

PLANS PRIOR TO BID OR MATERIAL PURCHASE.

- 7. VERIFY ALL ELECTRICAL CHARACTERISTICS WITH ELECTRICAL
- 8. WORK SHALL NOT BE COVERED UNTIL IT HAS BEEN INSPECTED, TESTED AND APPROVED BY THE PLUMBING INSPECTOR OR OTHER GOVERNMENTAL AUTHORITIES HAVING JURISDICTION.
- 9. PROVIDE ACCESS DOORS TO ALL CONCEALED VALVES.
 VALVES SHALL BE LINE SIZE UNLESS OTHERWISE NOTED.
- 10. FLUSH VALVES, FAUCETS, STOPS, BUBBLERS, ETC., SHALL BE ADJUSTED TO THEIR NORMAL WORKING CONDITIONS.
- 11. ALL LABOR AND MATERIALS SHALL BE GUARANTEED FOR ONE YEAR AFTER ACCEPTANCE OF THE COMPLETED WORK BY THE ARCHITECT, WITH SERVICE, REPLACEMENT OR REPAIR MADE AT NO EXTRA COST TO THE OWNER OR TENANT.
- 12. RECOMPACT ALL PLUMBING EXCAVATION.
- 13. ALL MATERIALS, EQUIPMENT, INSTALLATION, ETC., SHALL CONFORM TO ALL REQUIREMENTS OF ALL APPLICABLE CITY, COUNTY, STATE AND FEDERAL CODES, ORDINANCES & REGULATIONS.
- 14. VERIFY SIZE, LOCATION, DEPTH, ETC., OF ALL UTILITIES IN THE FIELD.
- 15. FURNISH AND INSTALL ALL BACK FLOW PROTECTION AS REQUIRED BY STATE AND LOCAL HEALTH DEPT. AND APPLICABLE CODES.
- 16. PLUMBING CONTRACTOR TO FURNISH AND INSTALL ALL SUPPLIES, STOPS, TRAPS, VALVES, SHOCK—STOPS, REGULATORS AND BACK FLOW PROTECTION PER CODE TO OWNER'S FURNISHED SINKS AND EQUIPMENT.
- 17. PLUMBING CONTRACTOR TO SET IN PLACE ALL OWNER FURNISHED EQUIPMENT ON FIXTURE CONNECTION SCHEDULE AS DETAILED OR DIRECTED IN FIELD.
- 18. ALL SINKS AND LAVATORIES IN FOOD FACILITY AREAS SHALL BE SUPPLIED WITH A MIN. OF 120° F. HOT WATER.
- 19. ALL WORK SHALL CONFORM TO ALL APPLICABLE CODES AND ORDINANCES, AND SHALL CONFORM TO THE CALIFORNIA PLUMBING CODE, LATEST EDITION. (2013)
- 20. ALL PIPING IN FINISHED AREAS SHALL BE CONCEALED WHERE POSSIBLE, AND EXPOSED PIPING SHALL BE RUN AS HIGH AS POSSIBLE AND TIGHT TO WALLS.
- 21. REFER TO AIR CONDITIONING PLANS FOR DRAINS, ETC., FROM EQUIPMENT.
- 22. INSULATE TAILPIECE, TRAP AND WATER LINES UNDER LAVATORIES DESIGNED FOR HANDICAP USE.
- 23. ALL INDIRECT DRAINS SHALL CONFORM TO CHAPTER 8, SECT. 803.0 CALIFORNIA PLUMBING CODE (2013).
- 24. THE PIPE SYSTEM SHALL BE FLUSHED WITH CLEAN, POTABLE WATER PER CHAPTER 6, SEC. 609.9 CALIFORNIA PLUMBING CODE (2013).
- 25. ALL FIXTURES, EQUIPMENT, PIPING, FITTINGS, AND MATERIALS SHALL BE LISTED.
- 26. ALL PLUMBING FIXTURES SHALL MEET THE FLOW REQUIREMENTS SPECIFIED IN THE CALIFORNIA PLUMBING CODE.
- 27. ALL FAUCETS IN PUBLIC RESTROOMS SHALL BE SELF-CLOSING OR SELF-CLOSING METERING FAUCETS.
- 28. PUBLIC LAVATORIES SHALL HAVE CONTROLS TO LIMIT THE WATER TEMPERATURE TO 120°.
- 29. WATER PIPE AND FITTINGS WITH A LEAD CONTENT WHICH EXCEEDS 0.25% SHALL BE PROHIBITED IN SYSTEMS CONVEYING POTABLE WATER.
- D. THE PRESSURE REGULATING VALVE (PRV) SHALL BE INSTALLED AT ABOVE GRADE OR FINISHED FLOOR. THE PRV SHALL NOT BE INSTALLED IN A PIT WHERE IT CAN BECOME SUBMERGED IN WATER.

GENERAL NOTES

- 31. THE REDUCED PRESSURE BACKFLOW DEVICE (RP) SHALL BE INSTALLED AT LEAST 12 INCHES ABOVE GRADE OR FINISHED FLOOR. THE RP SHALL NOT BE INSTALLED IN A PIT WHERE IT CAN BECOME SUBMERGED IN WATER.
- 32. THE SEISMIC GAS SHUT-OFF VALVE SHALL BE MOUNTED RIGIDLY TO THE EXTERIOR OF THE BUILDING OR STRUCTURE CONTAINING THE FUEL GAS PIPING.
- FOR NEWLY INSTALLED SHOWERHEADS, WHEN SINGLE SHOWER FIXTURES ARE SERVED BY MORE THAN ONE SHOWERHEAD, THE COMBINED FLOW RATE OF ALL THE SHOWERHEADS CONTROLLED BY A SINGLE VALVE SHALL NOT EXCEED THE MAXIMUM FLOW RATES SPECIFIED IN THE MAXIMUM ALLOWABLE FLOW RATE COLUMN CONTAINED IN TABLE 10.303.2.3 OR THE SHOWER SHALL BE DESIGNED ONLY ALLOW ONE SHOWERHEAD TO BE IN OPERATION AT A TIME.
- 34. SITES THAT PROVIDE A WATER SERVICE UPGRADE AND CONTAIN AT LEAST 1,000 SQ.FT. OF CUMULATIVE LANDSCAPE AREAS BEING SERVED BY A POTABLE WATER SERVICE SHALL HAVE SEPARATE METERS OR SUB-METERS FOR INDOOR AND OUTDOOR POTABLE WATER USE.
- 35. NEW PLUMBING FIXTURES AND FITTINGS SHALL NOT EXCEED THE MAXIMUM ALOWABLE FLOW RATE SPECIFIED IN SECTION 5,303,2 AND TABLE 10,303,2,3
- 36. INSTALL WATER HAMMER ARRESTORS ON EACH COLD AND HOT WATER FIXTURE BRANCH AS RECOMMENDED BY PLUMBING AND DRAINAGE INSTITUTE WH—210 STANDARD. DEVICES SHALL BE FACTORY MADE WITH PERMANENT CUSHION OF GAS OR AIR. PROVIDE ACCESS PANEL.
- 37. GAS PIPING UNDERGROUND BENEATH BUILDING SHALL BE INSTALLED EITHER PER SECTION 1210.1.6.1 OR SECTION 1210.1.6.2 2013 CPC,
- 38. INSTALL CAST IRON PIPE, COPPER PIPE, AND FITTINGS BELOW GRADE INSIDE 8 MIL POLYETHYLENE TUBE PER AWWA-C-105 OR ANSI B215.
- 39. IT IS NOT INTENDED THAT THE DRAWINGS SHALL SHOW EVERY PIPE, FITTING, VALVE AND APPLIANCE. ALL SUCH ITEMS WHETHER SPECIFICALLY MENTIONED OR NOT, OR INDICATED ON THE DRAWINGS SHALL BE FURNISHED AND INSTALLED, IF NECESARY, TO COMPLETE THE SYSTEM IN ACCORDANCE WITH THE BEST PRACTICE OF THE PLUMBING TRADE AND TO THE SATISFACTION OF THE ENGINEER AND THE OWNER.
- 40. ALL FLOOR DRAINS AND FLOOR SINKS SHALL BE PROVIDED WITH TRAP PRIMER AND ACCESS PANEL.
- 41. ALL REQUIRED CLEANOUTS SHALL BE INSTALLED AS PER SEC. 707.0 & 719.0 OF THE CALIFORNIA PLUMBING CODE.
- 43. WATER CLOSET BOWLS FOR PUBLIC USE SHALL BE OF THE ELONGATED TYPE.
- 44. WATER SUPPLY CONNECTION TO COMMERCIAL DISHWASHING MACHINE SHALL BE PROTECTED BY AN AIR GAP OR BACKFLOW PREVENTION DEVICE PER SECTION 603 OF THE CALIFORNIA PLUMBING CODE.
- 45. POTABLE WATER SUPPLY TO BEVERAGE DISPENSERS, CARBONATORS, OR COFFEE MACHINES SHALL BE PROTECTED BY AN AIR GAP OR A VENTED BACKFLOW PREVENTER IN ACCORDANCE WITH ASSE 1022.
- 46. ALL HOSE BIBBS SHALL BE EQUIPPED WITH AN APPROVED NON-REMOVABLE VACUUM BREAKER.
- 47. NEW OR REPAIRED POTABLE WATER SYSTEM SHALL BE DISINFECTED PRIOR TO USE ACCORDING TO THE METHOD SET IN SECTION 609.9 OF THE PLUMBING CODE.
- 48. PUBLIC LAVATORIES SHALL HAVE A WATER TEMPERING DEVICE THAT COMPLIES W/ASSE 1070 OR CSA B125.3.
- 49. WATER PRESSURE ARRESTORS SHALL BE INSTALLED AS CLOSE AS POSSIBLE TO QUICK-ACTING VALVES AT THE END OF LONG PIPE OR NEAR BATTERIES OF FIXTURES OR BOTH.
- 50. HORIZONTAL VENTS BELOW THE THE FLOOD LEVEL RIM OF THE FIXTURE NOT ALLOWED FOR PLUMBING FIXTURES THAT ARE WITHIN TRAP ARM DISTANCE OF WALLS.
- 51. ALL PIPING SHALL BE DEBURRED/REAMED TO FULL BORE OF PIPE.
- 52. NO MORE THAN ONE—THIRD (1/3) OF THE TOTAL PERMITTED LENGTH, PER 2019 CALIFORNIA PLUMBING CODE TABLE 703.2, OF ANY MINIMUM SIZED VENT SHALL BE INSTALLED IN A HORIZONTAL POSITION.
- 53. PLUMBING PENETRATIONS THROUGH OCCUPANCY
 SEPARATIONS SHALL BE BOXED OUT AND FILLED WITH
 APPROVED SAFING MATERIAL. INSULATION NOT APPROVED.
- 54. PLUMBING FIXTURES AND FITTINGS SHALL BE INSTALLED IN ACCORDANCE WITH THE CALIFORNIA PLUMBING CODE, AND SHALL MEET APPLICABLE STANDARDS REFERENCED IN TABLE 1701.1 OF THE CALIFORNIA PLUMBING CODE.
- 55. SHOWER TUB-SHOWER COMBINATION SHALL HAVE INDIVIDUAL SHOWER CONTROL VALVE OF THE PRESSURE BALANCE OR THERMOSTATIC MIXING VALVE TYPE, SET AT 120F MAXIMUM.
- 56. GAS METER SHALL BE INSTALLED PER GAS COMPANY AND PROTECTED PER GAS COMPANY AND OTHER LOCAL AUTHORITY

- 57. ALL FIXTURES, EQUIPMENT, PIPING, AND MATERIALS SHALL BE LISTED TO APPROVED STANDARDS BY AN RECOGNIZED THIRD-PARTY LISTING AGENCY.
- 58. ALL PLUMBING FIXTURES SHALL MEET THE FLOW REQUIREMENTS SPECIFIED
 IN THE CALIFORNIA PLUMBING CODE & CALIFORNIA CODE WHICHEVER IS STRING
- IN THE CALIFORNIA PLUMBING CODE & CALGREEN CODE WHICHEVER IS STRINGENT.

 59. ALL FAUCETS IN PUBLIC RESTROOMS SHALL BE SELF—CLOSING METERING
- 60. PUBLIC LAVATORIES SHALL HAVE CONTROLS TO LIMIT THE WATER

FAUCETS.

- TEMPERATURE TO 110 DEGREE F.
 61. WATER PIPE AND FITTINGS WITH A LEAD CONTENT WHICH EXCEEDS 0.25%
- SHALL BE PROHIBITED IN SYSTEMS CONVEYING POTABLE WATER.

 62. LOCATIONS OF UTILITIES SHOWN ARE APPROXIMATE. CONTRACTOR SHALL VERIFY EXACT LOCATIONS AND DEPTHS OF UTILITIES PRIOR TO STARTING
- VERIFY EXACT LOCATIONS AND DEPTHS OF UTILITIES PRIOR TO STARTING WORK OF THIS SECTION. MAKE REQUIRED ADJUSTMENTS TO CONNECT TO UTILITIES. IF INDICATED POINTS OF CONNECTION CANNOT BE MADE TO EXISTING UTILITIES AS FOUND, THE CONTRACTOR SHALL, BEFORE CONTINUING, NOTIFY THE ENGINEER PRIOR TO INSTALLING ANY WORK WHICH MAY BE AFFECTED.
- 63. IT SHALL BE THE CONTRACTORS RESPONSIBILITY TO VERIFY AVAILABLE SPACES FOR INSTALLING THE WORK.
- 64. COORDINATION: THE DRAWINGS ARE DIAGRAMMATIC & INTENDED TO SHOW SCOPE. CONTRACTOR SHALL COORDINATE HIS WORK WITH OTHER TRADES TO PROVIDE BEST ARRANGEMENT OF ALL DUCT, PIPES, CONDUIT, ETC.
- 65. PROVIDE FELT WITH METAL BACKING VIBRATION ISOLATION SLEEVES OR PADS AT ALL PIPE HANGERS OR SUPPORTS AND ALL POINTS WHERE PIPING COMES IN CONTACT WITH ANY PORTION OF THE STRUCTURE. APPLIES TO ALL WATER AND WASTE PIPING. PROVIDE FELT AROUND ALL PVC PIPING AT SUPPORTS FOR THERMAL EXPANSION.
- 66. ALL PIPES, DUCTS AND CONDUITS SHALL BE SUPPORTED AND BRACED PER
- "SMACNA" GUIDE LINES.

 67. PLUMBERS TAPE WILL NOT BE ACCEPTED AS A PERMANENT SUPPORT FOR ANY PIPING OR DEVICES.
- 68. VALVES SHALL FULL FLOW 1/4 TURN BALL TYPE BY NIBCO, WATTS, CRANE, STOCKHAM OR EQUAL. SERVICE PRESSURE SHALL BE SUITABLE FOR SERVICE INTENDED. PROVIDE AND INSTALL IDENTIFICATION TAGS ON ALL VALVES. VALVES IN EXPOSED COMMON AREAS TO HAVE LOCKING HANDLES. NO IRON BODY VALVES WILL BE ACCEPTED.
- 69. PROVIDE AND INSTALL DIELECTRIC UNIONS BETWEEN ALL COPPER AND GALVANIZED & IRON PIPING & COMPONENTS. (AS WATTS, ZURN OR EQUAL).
- 70. PENETRATIONS IN WALLS, FLOORS, OR CEILINGS, WHICH REQUIRE PROTECTED OPENINGS SHALL BE FIRE—STOPPED, FIRE—STOPPING SHALL BE AN APPROVED MATERIAL, SECURELY INSTALLED AND CAPABLE OF MAINTAINING ITS INTEGRITY WHEN SUBJECTED TO THE TIME—TEMPERATURE CURVED OF SFM STD. # 12-43-3 AND STD. # 12-43-1. INSTALLATION INSTRUCTIONS SHALL BE MADE AVAILABLE TO THE INSPECTION AUTHORITY AND BE MAINTAINED AT THE JOB SITE.
- 71. PROVIDE WATERTIGHT FLASHING WHEREVER PIPES PASS THROUGH EXTERIOR WALLS, ROOF
- 72. WATER, SEWER, VENT, FIRE AND GAS PIPES THROUGH CONCRETE WALLS AND FLOORS SHALL HAVE PIPE—SLEEVES WITH NON COMBUSTIBLE SEALING.
- 73. ALL HOSE BIBBS SHALL BE EQUIPPED W/ AN APPROVED NON REMOVABLE VACUUM BREAKER.
- 74. RUN A FULL SIZE DRAIN LINE FROM WATER HEATERS TEMPERATURE AND PRESSURE RELIEF VALVE TO NEAREST FLOOR SINK OR TO AN APPROVED LOCATION.
- 75. PROVIDE ACCESS DOORS TO ALL CONCEALED VALVES, STRAINERS, TRAP PRIMERS, ETC.76. ALL PIPING IN FINISHED AREAS SHALL BE RUN CONCEALED. EXPOSED PIPING, WHERE NECESSARY, SHALL RUN AS HIGH AS POSSIBLE AND TIGHT TO THE WALLS.
- 77. THE CONTRACTOR SHALL CONTACT THE ARCHITECT, ENGINEER OR OWNER PRIOR TO BIDDING FOR INTERPRETATIONS AND CLARIFICATIONS OF THE DESIGN AND INCLUDE IN HIS BID ALL COSTS TO MEET THE DESIGN INTENT. CLARIFICATIONS MADE BY THE ARCHITECT, ENGINEER OR OWNER AFTER BIDDING WILL BE FINAL AND SHALL BE IMPLEMENTED AT CONTRACTORS COST.
- 78. BIDDING CONTRACTORS SHALL HAVE A WORKING KNOWLEDGE OF LOCAL CODES AND ORDINANCES AND SHALL INCLUDE IN BIDS THE COSTS FOR ALL WORK INSTALLED IN STRICT ACCORDANCE WITH GOVERNING CODES, THE PLANS AND SPECIFICATIONS NOT WITHSTANDING. THE CONTRACTOR SHALL ALERT ARCHITECT, ENGINEER OR OWNER OF ANY APPARENT DISCREPANCIES BETWEEN GOVERNING CODES AND DESIGN INTENT.
- 79. THE CONTRACTOR SHALL FURNISH ALL LABOR, SUPERVISION, MATERIALS, EQUIPMENT & FACILITIES NECESSARY TO FURNISH, FABRICATE, DELIVER, STORE AND INSTALL ALL WORK NOTED ON THE DRAWINGS.
- THE CONTRACTOR SHALL FURNISH & INSTALL ALL WORK NECESSARY TO MAKE A COMPLETE SYSTEM WHETHER OR NOT SUCH DETAILS ARE MENTIONED IN THESE SPECIFICATIONS OR SHOWN ON THE PLANS, BUT WHICH ARE OBVIOUSLY NECESSARY TO MAKE A COMPLETE SYSTEM, EXCEPTING ONLY THOSE PORTIONS THAT ARE SPECIFICALLY MENTIONED HEREIN OR PLAINLY MARKED ON THE ACCOMPANYING DRAWINGS AS BEING INSTALLED UNDER ANOTHER SECTION OF THE SPECIFICATION.
- 80. SEWER PIPE SIZES THAT ARE 3 INCHES OR SMALLER SHALL BE SLOPED AT 2%
- 81. IN ORDER TO MAINTAIN SLOPE OF HORIZONTAL DRAINAGE PIPING, DOUBLE COMBINATION FITTING IS NOT PERMITTED TO INSTALL IN HORIZONTAL POSITION. AS AN ALTERNATIVE, TWO COMBINATION WYE AND 1/8 BEND FITTINGS MAY BE USED.
- 82. NO VENT OUTLET SHALL TERMINATE CLOSER THAN FOUR FEET TO OR ONE FOOT ABOVE ANY DOOR, WINDOW OR GRAVITY AIR INTAKE, NOR CLOSER THAN TEN FEET TO OR THREE FEET ABOVE ANY FORCED OR MECHANICAL AIR INTAKE.
- 83. TYPE B VENTS SHALL TERMINATE 2 FT. ABOVE OR 8 FT. AWAY FROM ANY VERTICAL SURFACE.
- 84. PROVIDE HIGH AND LOW COMBUSTION FOR THE WATER HEATERS AND ALL OTHER GAS BURNING APPLIANCES REQUIRING COMBUSTION AIR AS PER CODE. EXACT LOCATION AND ROUTING TO BE APPROVED BY THE ARCHITECT AND AUTHORITIES HAVING JURISDICTION.
- 85. WATER HEATERS AND STORAGE TANKS SHALL BE SEISMICALLY BRACED.

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PLUMBING GENERAL NOTES

SHEET NO:

P1.0

PLUMBING SHEET INDEX SHEET # P1.0 PLUMBING GENERAL NOTES AND SHEET INDEX PLUMBING CALCULATIONS PLUMBING SCHEDULE AND DETAILS PLUMBING DETAILS P2.1A PLUMBING ENLARGED PARTIAL FIRST FLOOR WATER AND GAS PLAN P2.1B PLUMBING ENLARGED PARTIAL FIRST FLOOR WATER AND GAS PLAN P2.1.1A PLUMBING ENLARGED PARTIAL FIRST FLOOR WASTE AND VENT PLAN P2.1.1B PLUMBING ENLARGED PARTIAL FIRST FLOOR WASTE AND VENT PLAN P2.2A PLUMBING ENLARGED PARTIAL SECOND FLOOR WATER AND GAS PLAN P2.2B PLUMBING ENLARGED PARTIAL SECOND FLOOR WATER AND GAS PLAN P2.2.1A PLUMBING ENLARGED PARTIAL SECOND FLOOR WASTE AND VENT PLAN P2.2.1B PLUMBING ENLARGED PARTIAL SECOND FLOOR WASTE AND VENT PLAN PLUMBING ROOF PLAN PLUMBING HOT AND COLD WATER RISER DIAGRAMS PLUMBING WASTE AND VENT RISER DIAGRAMS PLUMBING GAS RISER DIAGRAMS

(22) UNITS		······································				
WASTE FIXTURE CALCULA	ATION:					TOTAL
(e)fixture		NUMBER OF FIXTURES	Х	FIXTURE UNITS	=	TOTAL FIXTURE UNITS
WATER CLOSET (PRIVATE)	•	1	X	3	***	3
LAVATORY (PRIVÀTE) BATHTUB/SHOWER (PRIVATE)		1	X X	1 2	=	1 2
TOTAL WASTE FIXTURE UNITS						- 6 TOTAL
ROOMS—SECOND FLOOR					···	
<u>(23) UNITS</u> WASTE FIXTURE CALCUL	ATION:					
		NUMBER OF	Х	FIXTURE	***	TOTAL FIXTURE
<u>(e)fixture</u> Water Closet (private)	•	<u>FIXTURES</u> 1		<u>UNITS</u>	***	<u>UNITS</u> 3
LAVATORY (PRIVÀTE) BATHTUB/SHOWER (PRIVATE)		1	X X X	1 2	=	1 2
TOTAL WASTE FIXTURE UNITS						6 TOTAL
EXISTING LAUNDRY-FIRST FLOOR	<u> </u>			······································	<u></u>	
<u>(1) UNIT</u> WASTE FIXTURE CALCUL	ATION:					an a m . 1
		NUMBER OF	X	FIXTURE	=	TOTAL FIXTURE
<u>(e)fixture</u> Clothes washer		FIXTURES 1	X	UNITS 52 (ASSU)	viE) =	<u>UNITS</u> 52
TOTAL WASTE FIXTURE UNITS				` _		52 <u>TOTAL</u>
(E)ROOMS CONVERTED TO ADA-FIRS	T FLOOR				·····	
(2) UNITS-ROOMS 119 & 120						
WASTE FIXTURE CALCUL		NUMBER OF	-	FIXTURE		TOTAL FIXTURE
(E)FIXTURE		FIXTURES 1	X	UNITS	=	UNITS 3
WATER CLOSET (PRIVATE) LAVATORY (PRIVATE) SHOWER STALL (PRIVATE)		1	X	3 1	===	1
(CHANGED TUB/SHOWER TO		STALL)	X	2	=	2
TOTAL WASTE FIXTURE UNITS						6 JOTAL
(E) TOTAL WASTE FIXTURES:						
/r\mytune	NUMBER	OF X	FIXTUR	E _	TOTAL	RE
<u>(e)fixture</u> first floor	FIXTURES 22	<u>; </u>	<u>UNITS</u>		<u>UNITS</u>	
SECOND FLOOR	23	X	6	=	138	3
existing Laundry Total existing waste fixtu	1 IRE LINIT	X ~~~~~	52		$\frac{52}{322}$	2 TOTAL
TOTAL EXISTING WASTE TIATO	JAE ONI	3			- 322	TOTAL
NEW(N) FIXTURES						<u> </u>
ROOMS-FIRST FLOOR (22) UNITS						
WASTE FIXTURE CALCUL	ATION:					TOTAL
(N)FIXTURE		NUMBER OF FIXTURES	X	FIXTURE UNITS	==	FIXTURE UNITS
KITCHEN SINK (PRIVATE)		1	X	2	=	2
TOTAL WASTE FIXTURE UNITS	<u> </u>					- 2 <u>TOTA</u>
						<u>. </u>
RESTROOM (ADA)-FIRST FLOOR						
WASTE FIXTURE CALCUL	ATION:					TOTAL
(N)FIXTURE	-	NUMBER OF FIXTURES	X	FIXTURE UNITS	=	TOTAL FIXTURE UNITS
WATER CLOSET (PUBLIC)		1	X	<u>UNITS</u> 4	=	<u>UNIS</u> 4
LAVATORY (PUBLIC)	•	1	X	1	=	1
TOTAL WASTE FIXTURE UNITS	<u> </u>					5 <u>TOTA</u>
LAUNDRY-FIRST FLOOR (1) UNIT						
WASTE FIXTURE CALCUL	ATION:					TOTAL
(N)FIXTURE		NUMBER OF FIXTURES	x	FIXTURE UNITS	=	FIXTURE UNITS
THE WINDS						6
CLOTHES WASHER		2	^	3	***	_
CLOTHES WASHER HAND SINK FLOOR DRAIN		1 1	X X X	3 2 6	=	2 _6
HAND SINK	5	1 1	X X	2	===	
HAND SINK FLOOR DRAIN TOTAL WASTE FIXTURE UNITS ROOMS—SECOND FLOOR	5	1	× ×	2	===	_6_
HAND SINK FLOOR DRAIN TOTAL WASTE FIXTURE UNITS ROOMS-SECOND FLOOR (23) UNITS		1 1	X X	2	===	_6_
HAND SINK FLOOR DRAIN TOTAL WASTE FIXTURE UNITS ROOMS-SECOND FLOOR (23) UNITS WASTE FIXTURE CALCUL		1 1 NUMBER OF	X	2		
HAND SINK FLOOR DRAIN TOTAL WASTE FIXTURE UNITS ROOMS-SECOND FLOOR (23) UNITS WASTE FIXTURE CALCUL (N)FIXTURE		1 1 NUMBER OF FIXTURES	X	2 6 FIXTURE UNITS		6
HAND SINK FLOOR DRAIN TOTAL WASTE FIXTURE UNITS ROOMS-SECOND FLOOR (23) UNITS WASTE FIXTURE CALCUL	ATION:	NUMBER OF	X	2 6 FIXTURE		
HAND SINK FLOOR DRAIN TOTAL WASTE FIXTURE UNITS ROOMS-SECOND FLOOR (23) UNITS WASTE FIXTURE CALCUL (N)FIXTURE KITCHEN SINK (PRIVATE) TOTAL WASTE FIXTURE UNITS	ATION:	1 1 NUMBER OF FIXTURES	X	2 6 FIXTURE UNITS		TOTAL FIXTURE UNITS 46
HAND SINK FLOOR DRAIN TOTAL WASTE FIXTURE UNITS ROOMS-SECOND FLOOR (23) UNITS WASTE FIXTURE CALCUL (N)FIXTURE KITCHEN SINK (PRIVATE) TOTAL WASTE FIXTURE UNITS LAUNDRY-SECOND FLOOR (1) UNIT	ATION:	NUMBER OF FIXTURES 23	X	2 6 FIXTURE UNITS		TOTAL FIXTURE UNITS 46
HAND SINK FLOOR DRAIN TOTAL WASTE FIXTURE UNITS ROOMS-SECOND FLOOR (23) UNITS WASTE FIXTURE CALCUL (N)FIXTURE KITCHEN SINK (PRIVATE) TOTAL WASTE FIXTURE UNITS LAUNDRY-SECOND FLOOR	ATION:	NUMBER OF FIXTURES 23	X	FIXTURE UNITS 2		TOTAL FIXTURE UNITS 46 46 TOTAL
HAND SINK FLOOR DRAIN TOTAL WASTE FIXTURE UNITS ROOMS-SECOND FLOOR (23) UNITS WASTE FIXTURE CALCUL (N)FIXTURE KITCHEN SINK (PRIVATE) TOTAL WASTE FIXTURE UNITS LAUNDRY-SECOND FLOOR (1) UNIT	ATION:	NUMBER OF FIXTURES 23	X	2 6 FIXTURE UNITS		TOTAL FIXTURE UNITS 46 46 TOTAL
HAND SINK FLOOR DRAIN TOTAL WASTE FIXTURE UNITS ROOMS-SECOND FLOOR (23) UNITS WASTE FIXTURE CALCUL (N)FIXTURE KITCHEN SINK (PRIVATE) TOTAL WASTE FIXTURE UNITS LAUNDRY-SECOND FLOOR (1) UNIT WASTE FIXTURE CALCUL (N)FIXTURE FLOOR DRAIN	ATION:	NUMBER OF FIXTURES 23	X X X	FIXTURE UNITS 2		TOTAL FIXTURE UNITS 46 46 TOTAL FIXTURE UNITS 46 46 TOTAL FIXTURE UNITS 6
HAND SINK FLOOR DRAIN TOTAL WASTE FIXTURE UNITS ROOMS-SECOND FLOOR (23) UNITS WASTE FIXTURE CALCUL (N)FIXTURE KITCHEN SINK (PRIVATE) TOTAL WASTE FIXTURE UNITS LAUNDRY-SECOND FLOOR (1) UNIT WASTE FIXTURE CALCUL (N)FIXTURE FLOOR DRAIN TOTAL WASTE FIXTURE UNITS	ATION:	NUMBER OF FIXTURES 23	x x x	FIXTURE UNITS 2 FIXTURE UNITS		TOTAL FIXTURE UNITS TOTAL FIXTURE UNITS
HAND SINK FLOOR DRAIN TOTAL WASTE FIXTURE UNITS ROOMS-SECOND FLOOR (23) UNITS WASTE FIXTURE CALCUL (N)FIXTURE KITCHEN SINK (PRIVATE) TOTAL WASTE FIXTURE UNITS LAUNDRY-SECOND FLOOR (1) UNIT WASTE FIXTURE CALCUL (N)FIXTURE FLOOR DRAIN	ATION:	NUMBER OF FIXTURES 23 NUMBER OF FIXTURES 1	X X X	FIXTURE UNITS 2 FIXTURE UNITS 6	TOTAL	TOTAL FIXTURE UNITS 46 46 TOTAL FIXTURE UNITS 6 6 6 TOTAL
HAND SINK FLOOR DRAIN TOTAL WASTE FIXTURE UNITS ROOMS-SECOND FLOOR (23) UNITS WASTE FIXTURE CALCUL (N)FIXTURE KITCHEN SINK (PRIVATE) TOTAL WASTE FIXTURE UNITS LAUNDRY-SECOND FLOOR (1) UNIT WASTE FIXTURE CALCUL (N)FIXTURE FLOOR DRAIN TOTAL WASTE FIXTURE UNITS (NEW) TOTAL WASTE FIXTURES:	ATION: ATION: S NUMBER FIXTURE	NUMBER OF FIXTURES 23 NUMBER OF FIXTURES 1	X X X X FIXTUR UNITS	FIXTURE UNITS 2 FIXTURE UNITS 6	TOTAL FIXTU UNITS	TOTAL FIXTURE UNITS 46 46 TOTAL FIXTURE UNITS 6 6 TOTAL FIXTURE UNITS 6 6 TOTAL FIXTURE UNITS
HAND SINK FLOOR DRAIN TOTAL WASTE FIXTURE UNITS ROOMS-SECOND FLOOR (23) UNITS WASTE FIXTURE CALCUL (N)FIXTURE KITCHEN SINK (PRIVATE) TOTAL WASTE FIXTURE UNITS LAUNDRY-SECOND FLOOR (1) UNIT WASTE FIXTURE CALCUL (N)FIXTURE FLOOR DRAIN TOTAL WASTE FIXTURE UNITS (NEW) TOTAL WASTE FIXTURES: (NEW)FIXTURE FIRST FLOOR	ATION: S ATION: S NUMBER FIXTURE 22	NUMBER OF FIXTURES 23 NUMBER OF FIXTURES 1	X X X X FIXTUR UNITS 2	FIXTURE UNITS 2 FIXTURE UNITS 6	TOTAL FIXTU UNITS	TOTAL FIXTURE UNITS 46 46 TOTAL FIXTURE UNITS 6 6 6 10TAL FIXTURE UNITS 6 4
HAND SINK FLOOR DRAIN TOTAL WASTE FIXTURE UNITS ROOMS-SECOND FLOOR (23) UNITS WASTE FIXTURE CALCUL (N)FIXTURE KITCHEN SINK (PRIVATE) TOTAL WASTE FIXTURE UNITS LAUNDRY-SECOND FLOOR (1) UNIT WASTE FIXTURE CALCUL (N)FIXTURE FLOOR DRAIN TOTAL WASTE FIXTURE UNITS (NEW) TOTAL WASTE FIXTURE UNITS (NEW) TOTAL WASTE FIXTURES: (NEW)FIXTURE FIRST FLOOR SECOND FLOOR MANAGER'S LIVING QUARTER'	ATION: S ATION: S NUMBER FIXTURE 22 23	NUMBER OF FIXTURES 23 NUMBER OF FIXTURES 1 OF X X X X X	X X X X FIXTUR UNITS 2 2 11	FIXTURE UNITS 2 FIXTURE UNITS 6	TOTAL FIXTU UNITS 4 4 1	TOTAL FIXTURE UNITS 46 46 TOTAL FIXTURE UNITS 6 6 6 TOTAL FIXTURE UNITS 6 6 1
HAND SINK FLOOR DRAIN TOTAL WASTE FIXTURE UNITS ROOMS-SECOND FLOOR (2-3) UNITS WASTE FIXTURE CALCUL (N)FIXTURE KITCHEN SINK (PRIVATE) TOTAL WASTE FIXTURE UNITS LAUNDRY-SECOND FLOOR (1) UNIT WASTE FIXTURE CALCUL (N)FIXTURE FLOOR DRAIN TOTAL WASTE FIXTURE UNITS (NEW) TOTAL WASTE FIXTURE UNITS (NEW) TOTAL WASTE FIXTURES: (NEW)FIXTURE FIRST FLOOR SECOND FLOOR MANAGER'S LIVING QUARTER' RESTROOM (ADA) STAFF OFFICE BREAK ROOM	ATION: S ATION: S NUMBER FIXTURE 22 23 'S 1 1 1	NUMBER OF FIXTURES 23 NUMBER OF FIXTURES 1 OF X X X X X	X X X X FIXTUR UNITS 2 2 11 5 2	FIXTURE UNITS 2 FIXTURE UNITS 6	TOTAL FIXTU UNITS 4 1	TOTAL FIXTURE UNITS 46 46 TOTAL FIXTURE UNITS 6 6 TOTAL FIXTURE UNITS 6 1 5 2
HAND SINK FLOOR DRAIN TOTAL WASTE FIXTURE UNITS ROOMS-SECOND FLOOR (23) UNITS WASTE FIXTURE CALCUL (N)FIXTURE KITCHEN SINK (PRIVATE) TOTAL WASTE FIXTURE UNITS LAUNDRY-SECOND FLOOR (1) UNIT WASTE FIXTURE CALCUL (N)FIXTURE FLOOR DRAIN TOTAL WASTE FIXTURE UNITS (NEW) TOTAL WASTE FIXTURES: (NEW)FIXTURE FIRST FLOOR SECOND FLOOR MANAGER'S LIVING QUARTER' RESTROOM (ADA) STAFF OFFICE BREAK ROOM LAUNDRY ROOM—FIRST FLOOR	ATION: S ATION: S NUMBER FIXTURE 22 23 'S 1 1 10R 1	NUMBER OF FIXTURES 23 NUMBER OF FIXTURES 1 OF X X X X X	X X X X FIXTUR UNITS 2 2 11	FIXTURE UNITS 2 FIXTURE UNITS 6	TOTAL FIXTU UNITS 4 4 1	TOTAL FIXTURE UNITS 46 46 TOTAL FIXTURE UNITS 6 6 6 1 6 1 5
HAND SINK FLOOR DRAIN TOTAL WASTE FIXTURE UNITS ROOMS-SECOND FLOOR (2-3) UNITS WASTE FIXTURE CALCUL (N)FIXTURE KITCHEN SINK (PRIVATE) TOTAL WASTE FIXTURE UNITS LAUNDRY-SECOND FLOOR (1) UNIT WASTE FIXTURE CALCUL (N)FIXTURE FLOOR DRAIN TOTAL WASTE FIXTURE UNITS (NEW) TOTAL WASTE FIXTURE UNITS (NEW) TOTAL WASTE FIXTURES: (NEW)FIXTURE FIRST FLOOR SECOND FLOOR MANAGER'S LIVING QUARTER' RESTROOM (ADA) STAFF OFFICE BREAK ROOM	ATION: S ATION: S NUMBER FIXTURE 22 23 'S 1 1 10R 1 .00R 1	NUMBER OF FIXTURES 23 NUMBER OF FIXTURES 1 OF X X X X X X X	X X X X FIXTUR UNITS 2 2 11 5 2 8	FIXTURE UNITS 2 FIXTURE UNITS 6	TOTAL FIXTU UNITS 4 4 1	TOTAL FIXTURE UNITS 46 46 TOTAL FIXTURE UNITS 6 6 TOTAL FIXTURE UNITS 6 1 6 TOTAL FIXTURE UNITS 8 1 1 5 2 8
HAND SINK FLOOR DRAIN TOTAL WASTE FIXTURE UNITS ROOMS-SECOND FLOOR (23) UNITS WASTE FIXTURE CALCUL (N)FIXTURE KITCHEN SINK (PRIVATE) TOTAL WASTE FIXTURE UNITS LAUNDRY-SECOND FLOOR (1) UNIT WASTE FIXTURE CALCUL (N)FIXTURE FLOOR DRAIN TOTAL WASTE FIXTURE UNITS (NEW) TOTAL WASTE FIXTURES: (NEW)FIXTURE FIRST FLOOR SECOND FLOOR MANAGER'S LIVING QUARTER' RESTROOM (ADA) STAFF OFFICE BREAK ROOM LAUNDRY ROOM—FIRST FLOOR LAUNDRY ROOM—SECOND FL	ATION: S — NUMBER FIXTURE 22 23 'S 1 1 0R 1 0OR 1 UNITS	NUMBER OF FIXTURES 23 NUMBER OF FIXTURES 1 OF X X X X X X X X X	X X X X FIXTUR UNITS 2 2 11 5 2 8	FIXTURE UNITS 2 FIXTURE UNITS 6	TOTAL FIXTU UNITS 4 4 1	TOTAL FIXTURE UNITS 46 46 46 TOTAL FIXTURE UNITS 6 6 1 6 TOTAL FIXTURE UNITS 6 1 5 2 8 6
HAND SINK FLOOR DRAIN TOTAL WASTE FIXTURE UNITS ROOMS-SECOND FLOOR (2-3) UNITS WASTE FIXTURE CALCUL (N)FIXTURE KITCHEN SINK (PRIVATE) TOTAL WASTE FIXTURE UNITS LAUNDRY-SECOND FLOOR (1) UNIT WASTE FIXTURE CALCUL (N)FIXTURE FLOOR DRAIN TOTAL WASTE FIXTURE UNITS (NEW) TOTAL WASTE FIXTURES: (NEW)FIXTURE FIRST FLOOR SECOND FLOOR MANAGER'S LIVING QUARTER' RESTROOM (ADA) STAFF OFFICE BREAK ROOM LAUNDRY ROOM—FIRST FLOOL LAUNDRY ROOM—SECOND FL TOTAL NEW WASTE FIXTURE	ATION: S — NUMBER FIXTURE 22 23 'S 1 1 0R 1 0OR 1 UNITS	NUMBER OF FIXTURES 23 NUMBER OF FIXTURES 1 OF X X X X X X X X X	X X X X FIXTUR UNITS 2 2 11 5 2 8	FIXTURE UNITS 2 FIXTURE UNITS 6	TOTAL FIXTU UNITS 4 4 1	TOTAL FIXTURE UNITS 46 46 46 TOTAL FIXTURE UNITS 6 6 1 5 2 8 6 2 TOTAL 2 TOTAL 5 TOTAL FIXTURE UNITS 6 2 TOTAL FIXTURE UNITS 6 2 TOTAL

EXISTING WASTE FIXTURES 1 X 322 = 322 NEW WASTE FIXTURES 1 X 122 = 122

GRAND TOTAL WASTE FIXTURE UNITS -

EXISTING(E) FIXTURES				<u></u>		······································
ROOMS-FIRST FLOOR (22) UNITS						
WATER FIXTURE CALCUI	LATION:					TOTAL
(E)FIXTURE		NUMBER OF FIXTURES	X	FIXTURE UNITS	=	FIXTURE UNITS
WATER CLOSET (PRIVATE)	-	1	X	2.5	==	2.5
LAVATORY (PRIVATE) BATHTUB/SHOWER (PRIVATE)	1	X	4	=	4
TOTAL WASTE FIXTURE UNIT	<u>s</u>					- 7.5 <u>TO</u>
ROOMS-SECOND FLOOR						
(23) UNITS WATER FIXTURE CALCUI	A TION!					
		NUMBER OF	X	FIXTURE		TOTAL FIXTURE
(E)FIXTURE WATER CLOSET (PRIVATE)	_!	FIXTURES 1	X	<u>UNITS</u> 2.5	=	<u>UNITS</u> 2.5
LAVATORY (PRIVATE) BATHTUB/SHOWER (PRIVATE	1	1	X	1	=	1 4
TOTAL WASTE FIXTURE UNIT		*		7		+ 7.5 <u>IO</u>
EXISTING LAUNDRY-FIRST FLOOR						
(1) UNIT	LATION					
WATER FIXTURE CALCUI		NUMBER OF	v	FIXTURE		TOTAL FIXTURE
<u>(e)fixture</u> Clothes Washer	-	FIXTURES 1	X X	<u>UNITS</u> 26 (ASSUI	/E)_	UNITS 26
CLUINES WASHER		1	^	20 (1330)	VIE.)—	20
TOTAL WASTE FIXTURE UNIT	·s					<u>26_TOTA</u>
(E)ROOMS CONVERTED TO ADA-FIR	QOO ET TO					***************************************
(2) UNITS-ROOMS 119 & 120	SI PLOUR					
WATER FIXTURE CALCUI		131 (1 1 Mmm		fm3 ()ndut + nor nor		TOTAL
(E)FIXTURE		NUMBER OF FIXTURES	Χ	FIXTURE UNITS	=	FIXTURE UNITS
WATER CLOSET (PRIVATE) LAVATORY (PRIVATE)		1	X	2.5 1	=	2.5 1
LAVATORY (PRIVATE) SHOWER STALL (PRIVATE) (CHANGED TUB/SHOWER TO) CHUMED	1 STALL)	x	2		2
TOTAL WASTE FIXTURE UNIT		JINLL)				+ 5.5 <u>TO</u>
(E) TOTAL WATER FIXTURES:						
IT IN INT MAICH LIVINKES:	NUMBER	OF	FIXTURE		TOTAL FIXTUR	_{RF}
(E)FIXTURE	FIXTURES		UNITS	-	UNITS	
FIRST FLOOR SECOND FLOOR	22 23	X X	7.5 7.5	=	165 172	
EXISTING LAUNDRY	23 1	x	26	=	26	1
TOTAL EXISTING WATER FIX	TURE UNIT	<u>s – – – </u>			- 363	.5 TOTAL
(22) UNITS WATER FIXTURE CALCU		NUMBER OF		FIXTURE		TOTAL FIXTURE
WATER FIXTURE CALCU (N)FIXTURE KITCHEN SINK (PRIVATE)		NUMBER OF FIXTURES 1	X X	FIXTURE UNITS 1.5		FIXTURE UNITS 1.5
WATER FIXTURE CALCU (N)FIXTURE		<u>FIXTURES</u>		UNITS		FIXTURE UNITS
WATER FIXTURE CALCU (N)FIXTURE KITCHEN SINK (PRIVATE) TOTAL WATER FIXTURE UNIT RESTROOM (ADA)-FIRST FLOOR		<u>FIXTURES</u>		UNITS	=	FIXTURE UNITS 1.5
WATER FIXTURE CALCU (N)FIXTURE KITCHEN SINK (PRIVATE) TOTAL WATER FIXTURE UNIT RESTROOM (ADA)-FIRST FLOOR (1) UNIT	TS —	<u>FIXTURES</u>		UNITS	=	FIXTURE UNITS 1.5
WATER FIXTURE CALCU (N)FIXTURE KITCHEN SINK (PRIVATE) TOTAL WATER FIXTURE UNIT RESTROOM (ADA)-FIRST FLOOR	LATION:	1 NUMBER OF	X	<u>UNITS</u> 1.5	=	FIXTURE UNITS 1.5 1.5 TOTAL
WATER FIXTURE CALCU (N)FIXTURE KITCHEN SINK (PRIVATE) TOTAL WATER FIXTURE UNIT RESTROOM (ADA)-FIRST FLOOR (1) UNIT WATER FIXTURE CALCU (N)FIXTURE	LATION:	<u>FIXTURES</u>	X	1.5 FIXTURE UNITS		FIXTURE UNITS 1.5 1.5 TOTAL FIXTURE UNITS
(N)FIXTURE KITCHEN SINK (PRIVATE) TOTAL WATER FIXTURE UNIT RESTROOM (ADA)—FIRST FLOOR (1)—UNIT WATER FIXTURE CALCU (N)FIXTURE WATER CLOSET (PUBLIC) LAVATORY (PUBLIC)	LATION:	1 NUMBER OF	X	1.5 FIXTURE		TOTAL FIXTURE UNITS 2.5 1.5 1.5 1.5 1.5 1.5 1.5 1.5 1.5 1.5 1
WATER FIXTURE CALCU (N)FIXTURE KITCHEN SINK (PRIVATE) TOTAL WATER FIXTURE UNIT RESTROOM (ADA)—FIRST FLOOR (1) UNIT WATER FIXTURE CALCU (N)FIXTURE WATER CLOSET (PUBLIC)	LATION:	1 NUMBER OF	x x x	I.5 FIXTURE UNITS 2.5		TOTAL FIXTURE UNITS 2.5
WATER FIXTURE CALCU (N)FIXTURE KITCHEN SINK (PRIVATE) TOTAL WATER FIXTURE UNIT RESTROOM (ADA)—FIRST FLOOR (1) UNIT WATER FIXTURE CALCU (N)FIXTURE WATER CLOSET (PUBLIC) LAVATORY (PUBLIC) TOTAL WATER FIXTURE UNIT LAUNDRY—FIRST FLOOR	LATION:	1 NUMBER OF	x x x	I.5 FIXTURE UNITS 2.5		TOTAL FIXTURE UNITS 2.5 1.5 1.5 1.5 1.5 1.5 1.5 1.5 1.5 1.5 1
WATER FIXTURE CALCU (N)FIXTURE KITCHEN SINK (PRIVATE) TOTAL WATER FIXTURE UNIT RESTROOM (ADA)-FIRST FLOOR (1) UNIT WATER FIXTURE CALCU (N)FIXTURE WATER CLOSET (PUBLIC) LAVATORY (PUBLIC) TOTAL WATER FIXTURE UNIT LAUNDRY-FIRST FLOOR (1) UNIT	LATION:	1 NUMBER OF	x x x	I.5 FIXTURE UNITS 2.5		TOTAL FIXTURE UNITS 2.5 1.5 1.5 1.5 1.5 1.5 1.5 1.5 1.5 1.5 1
WATER FIXTURE CALCU (N)FIXTURE KITCHEN SINK (PRIVATE) TOTAL WATER FIXTURE UNIT RESTROOM (ADA)—FIRST FLOOR (1) UNIT WATER FIXTURE CALCU (N)FIXTURE WATER CLOSET (PUBLIC) LAVATORY (PUBLIC) TOTAL WATER FIXTURE UNIT LAUNDRY—FIRST FLOOR	LATION:	NUMBER OF FIXTURES 1 1	X X X	FIXTURE UNITS 2.5 1		TOTAL FIXTURE UNITS 2.5 1.5 TOTAL FIXTURE UNITS 2.5 1 TOTAL FIXTURE UNITS 1 TOTAL FIXTURE UNITS
WATER FIXTURE CALCU (N)FIXTURE KITCHEN SINK (PRIVATE) TOTAL WATER FIXTURE UNIT RESTROOM (ADA)—FIRST FLOOR (1) UNIT WATER FIXTURE CALCU (N)FIXTURE WATER CLOSET (PUBLIC) LAVATORY (PUBLIC) LAVATORY (PUBLIC) TOTAL WATER FIXTURE UNIT LAUNDRY—FIRST FLOOR (1) UNIT WATER FIXTURE CALCU (N)FIXTURE	LATION:	NUMBER OF FIXTURES 1 1 1 NUMBER OF FIXTURES	X X X	FIXTURE UNITS 1.5 FIXTURE UNITS		TOTAL FIXTURE UNITS 2.5 1.3.5 TOTAL FIXTURE UNITS TOTAL FIXTURE UNITS TOTAL FIXTURE UNITS
WATER FIXTURE CALCU (N)FIXTURE KITCHEN SINK (PRIVATE) TOTAL WATER FIXTURE UNIT RESTROOM (ADA)-FIRST FLOOR (1) UNLT WATER FIXTURE CALCU (N)FIXTURE WATER CLOSET (PUBLIC) LAVATORY (PUBLIC) TOTAL WATER FIXTURE UNIT LAUNDRY-FIRST FLOOR (1) UNLT WATER FIXTURE CALCU	LATION:	NUMBER OF FIXTURES 1 1 1 NUMBER OF	X X X	FIXTURE UNITS 2.5 1		TOTAL FIXTURE UNITS 2.5 1 3.5 TOTAL FIXTURE UNITS 2.5 1 TOTAL FIXTURE UNITS
WATER FIXTURE CALCU (N)FIXTURE KITCHEN SINK (PRIVATE) TOTAL WATER FIXTURE UNIT RESTROOM (ADA)-FIRST FLOOR (1) UNIT WATER FIXTURE CALCU (N)FIXTURE WATER CLOSET (PUBLIC) LAVATORY (PUBLIC) TOTAL WATER FIXTURE UNIT LAUNDRY-FIRST FLOOR (1) UNIT WATER FIXTURE CALCU (N)FIXTURE CLOTHES WASHER	LATION:	NUMBER OF FIXTURES 1 1 1 NUMBER OF FIXTURES 2	X X X X	FIXTURE UNITS 1.5 FIXTURE UNITS 4		TOTAL FIXTURE UNITS 2.5 1.3.5 TOTAL FIXTURE UNITS TOTAL FIXTURE UNITS 2.5 1 3.5 TOTAL FIXTURE UNITS 8
WATER FIXTURE CALCU (N)FIXTURE KITCHEN SINK (PRIVATE) TOTAL WATER FIXTURE UNIT RESTROOM (ADA)—FIRST FLOOR (1) UNIT WATER FIXTURE CALCU (N)FIXTURE WATER CLOSET (PUBLIC) LAVATORY (PUBLIC) TOTAL WATER FIXTURE UNIT LAUNDRY—FIRST FLOOR (1) UNIT WATER FIXTURE CALCU (N)FIXTURE CLOTHES WASHER HAND SINK TOTAL WATER FIXTURE UNIT	LATION:	NUMBER OF FIXTURES 1 1 1 NUMBER OF FIXTURES 2	X X X X	FIXTURE UNITS 1.5 FIXTURE UNITS 4		TOTAL FIXTURE UNITS 2.5 1.3.5 TOTAL FIXTURE UNITS 2.5 1 1.5.5 TOTAL FIXTURE UNITS 1.5.5 TOTAL FIXTURE UNITS 1.5.5 TOTAL FIXTURE UNITS
WATER FIXTURE CALCU (N)FIXTURE KITCHEN SINK (PRIVATE) TOTAL WATER FIXTURE UNIT RESTROOM (ADA)-FIRST FLOOR (1) UNIT WATER FIXTURE CALCU (N)FIXTURE WATER CLOSET (PUBLIC) LAVATORY (PUBLIC) TOTAL WATER FIXTURE UNIT LAUNDRY-FIRST FLOOR (1) UNIT WATER FIXTURE CALCU (N)FIXTURE CLOTHES WASHER HAND SINK	LATION:	NUMBER OF FIXTURES 1 1 1 NUMBER OF FIXTURES 2	X X X X	FIXTURE UNITS 1.5 FIXTURE UNITS 4		TOTAL FIXTURE UNITS 2.5 1.3.5 TOTAL FIXTURE UNITS 2.5 1 1.5.5.5 1 1.5.5.5 1.5.5 1.5 1
WATER FIXTURE CALCU (N)FIXTURE KITCHEN SINK (PRIVATE) TOTAL WATER FIXTURE UNIT RESTROOM (ADA)—FIRST FLOOR (1) UNIT WATER FIXTURE CALCU (N)FIXTURE WATER CLOSET (PUBLIC) LAVATORY (PUBLIC) TOTAL WATER FIXTURE UNIT LAUNDRY—FIRST FLOOR (1) UNIT WATER FIXTURE CALCU (N)FIXTURE CLOTHES WASHER HAND SINK TOTAL WATER FIXTURE UNIT ROOMS—SECOND FLOOR	LATION:	NUMBER OF FIXTURES 1 1 1 NUMBER OF FIXTURES 2	X X X X	FIXTURE UNITS 1.5 FIXTURE UNITS 4		TOTAL FIXTURE UNITS 2.5 1.5 TOTAL FIXTURE UNITS 2.5 1 3.5 TOTAL FIXTURE UNITS 9.5 10 TOTAL FIXTURE UNITS 8 1.5 9.5 TOTAL FIXTURE UNITS
WATER FIXTURE CALCU (N)FIXTURE KITCHEN SINK (PRIVATE) TOTAL WATER FIXTURE UNIT RESTROOM (ADA)-FIRST FLOOR (1) UNIT WATER FIXTURE CALCU (N)FIXTURE WATER CLOSET (PUBLIC) LAVATORY (PUBLIC) TOTAL WATER FIXTURE UNIT LAUNDRY-FIRST FLOOR (1) UNIT WATER FIXTURE CALCU (N)FIXTURE CLOTHES WASHER HAND SINK TOTAL WATER FIXTURE UNIT ROOMS-SECOND FLOOR (23) UNITS WATER FIXTURE CALCU	LATION:	NUMBER OF FIXTURES 1 NUMBER OF FIXTURES 2 1 1 NUMBER OF FIXTURES	X X X X	FIXTURE UNITS 2.5 1 FIXTURE UNITS 4 1.5		TOTAL FIXTURE UNITS 2.5 1.5 1.5 1.5 1.5 1.5 1.5 1.5 1.5 1.5 1
WATER FIXTURE CALCU (N)FIXTURE KITCHEN SINK (PRIVATE) TOTAL WATER FIXTURE UNIT RESTROOM (ADA)—FIRST FLOOR (1) UNIT WATER FIXTURE CALCU (N)FIXTURE WATER CLOSET (PUBLIC) LAVATORY (PUBLIC) TOTAL WATER FIXTURE UNIT LAUNDRY—FIRST FLOOR (1) UNIT WATER FIXTURE CALCU (N)FIXTURE CLOTHES WASHER HAND SINK TOTAL WATER FIXTURE UNIT ROOMS—SECOND FLOOR (23) UNITS	LATION:	NUMBER OF FIXTURES 1 NUMBER OF FIXTURES 2 1	X X X X	FIXTURE UNITS 2.5 1 FIXTURE UNITS 4 1.5		TOTAL FIXTURE UNITS 2.5 1.5 TOTAL FIXTURE UNITS 2.5 1 TOTAL FIXTURE UNITS 9.5 TOTAL FIXTURE UNITS 8 1.5 9.5 TOTAL FIXTURE UNITS 8 1.5 9.5 TOTAL FIXTURE UNITS
WATER FIXTURE CALCU (N)FIXTURE KITCHEN SINK (PRIVATE) TOTAL WATER FIXTURE UNIT RESTROOM (ADA)-FIRST FLOOR (1) UNIT WATER FIXTURE CALCU (N)FIXTURE WATER CLOSET (PUBLIC) LAVATORY (PUBLIC) TOTAL WATER FIXTURE UNIT LAUNDRY-FIRST FLOOR (1) UNIT WATER FIXTURE CALCU (N)FIXTURE CLOTHES WASHER HAND SINK TOTAL WATER FIXTURE UNIT ROOMS-SECOND FLOOR (23) UNITS WATER FIXTURE CALCU (N)FIXTURE	LATION:	NUMBER OF FIXTURES 1 NUMBER OF FIXTURES 2 1 1 NUMBER OF FIXTURES	X X X X	FIXTURE UNITS 1.5 FIXTURE UNITS 4 1.5		TOTAL FIXTURE UNITS 2.5 1.5 3.5 TOTAL FIXTURE UNITS 8 1.5 9.5 TOTAL FIXTURE UNITS 8 1.5 9.5 TOTAL FIXTURE UNITS
WATER FIXTURE CALCU (N)FIXTURE KITCHEN SINK (PRIVATE) TOTAL WATER FIXTURE UNIT RESTROOM (ADA)-FIRST FLOOR (1) UNIT WATER FIXTURE CALCU (N)FIXTURE WATER CLOSET (PUBLIC) LAVATORY (PUBLIC) TOTAL WATER FIXTURE UNIT LAUNDRY-FIRST FLOOR (1) UNIT WATER FIXTURE CALCU (N)FIXTURE CLOTHES WASHER HAND SINK TOTAL WATER FIXTURE UNIT ROOMS-SECOND FLOOR (23) UNITS WATER FIXTURE CALCU (N)FIXTURE KITCHEN SINK (PRIVATE) TOTAL WATER FIXTURE UNIT	LATION:	NUMBER OF FIXTURES 1 NUMBER OF FIXTURES 2 1 1 NUMBER OF FIXTURES	X X X X	FIXTURE UNITS 1.5 FIXTURE UNITS 4 1.5		TOTAL FIXTURE UNITS 2.5 1.5 1.5 TOTAL FIXTURE UNITS 2.5 1.5 9.5 TOTAL FIXTURE UNITS 8 1.5 9.5 TOTAL FIXTURE UNITS 1.5 1.5 1.5
WATER FIXTURE CALCU (N)FIXTURE KITCHEN SINK (PRIVATE) TOTAL WATER FIXTURE UNIT RESTROOM (ADA)-FIRST FLOOR (1) UNIT WATER FIXTURE CALCU (N)FIXTURE WATER CLOSET (PUBLIC) LAVATORY (PUBLIC) TOTAL WATER FIXTURE UNIT LAUNDRY-FIRST FLOOR (1) UNIT WATER FIXTURE CALCU (N)FIXTURE CLOTHES WASHER HAND SINK TOTAL WATER FIXTURE UNIT ROOMS-SECOND FLOOR (23) UNITS WATER FIXTURE CALCU (N)FIXTURE KITCHEN SINK (PRIVATE) TOTAL WATER FIXTURE UNIT (NEW) TOTAL WATER FIXTURE UNIT	LATION: IS — ILATION: IS — NUMBER	NUMBER OF FIXTURES 1 NUMBER OF FIXTURES 2 1 NUMBER OF FIXTURES 1 OF	X X X X	FIXTURE UNITS 2.5 1 FIXTURE UNITS 4 1.5 FIXTURE UNITS 1.5	TOTAL	TOTAL FIXTURE UNITS 2.5 1.5 3.5 TO TOTAL FIXTURE UNITS 8 1.5 9.5 TOTAL FIXTURE UNITS 1.5 1.5 1.5 1.5 1.5 1.5 1.5 1.5 1.5 1.
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WATER FIXTURE CALCU (N)FIXTURE KITCHEN SINK (PRIVATE) TOTAL WATER FIXTURE UNIT RESTROOM (ADA)-FIRST FLOOR (1) UNIT WATER FIXTURE CALCU (N)FIXTURE WATER CLOSET (PUBLIC) LAVATORY (PUBLIC) TOTAL WATER FIXTURE UNIT LAUNDRY-FIRST FLOOR (1) UNIT WATER FIXTURE CALCU (N)FIXTURE CLOTHES WASHER HAND SINK TOTAL WATER FIXTURE UNIT ROOMS-SECOND FLOOR (23) UNITS WATER FIXTURE CALCU (N)FIXTURE KITCHEN SINK (PRIVATE) TOTAL WATER FIXTURE UNIT (NEW) TOTAL WATER FIXTURES: (NEW)FIXTURE FIRST FLOOR SECOND FLOOR MANAGER'S LIVING QUARTER STAFF OFFICE BREAKROOM RESTROOM (ADA) LAUNDRY ROOM-FIRST FLO TOTAL NEW WATER FIXTURE BUILDING TOTAL WATER BUILDING TOTAL WATER	LATION: IS — LATION: IS — NUMBER FIXTURES 22 23 R'S 1 1 OR 1 E UNITS	NUMBER OF FIXTURES 1 NUMBER OF FIXTURES 2 1 NUMBER OF FIXTURES 1 NUMBER OF X X X X X X X X X X X	X X X X X X X 1.5 1.5 1.5 3.5	FIXTURE UNITS 1.5 FIXTURE UNITS 4 1.5 FIXTURE UNITS 4 1.5	TOTAL FIXTUIUNITS 33 34.5 15.3 1.5 3.9 99	TOTAL FIXTURE UNITS 1.5 1.5 1.5 1.5 1.5 1.5 1.5 1.
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WATER FIXTURE CALCU (N)FIXTURE KITCHEN SINK (PRIVATE) TOTAL WATER FIXTURE UNIT RESTROOM (ADA)-FIRST FLOOR (1) UNIT WATER FIXTURE CALCU (N)FIXTURE WATER CLOSET (PUBLIC) LAVATORY (PUBLIC) TOTAL WATER FIXTURE UNIT LAUNDRY-FIRST FLOOR (1) UNIT WATER FIXTURE CALCU (N)FIXTURE CLOTHES WASHER HAND SINK TOTAL WATER FIXTURE UNIT ROOMS-SECOND FLOOR (23) UNITS WATER FIXTURE CALCU (N)FIXTURE KITCHEN SINK (PRIVATE) TOTAL WATER FIXTURE UNIT (NEW) TOTAL WATER FIXTURES: (NEW)FIXTURE FIRST FLOOR SECOND FLOOR MANAGER'S LIVING QUARTER STAFF OFFICE BREAKROOM RESTROOM (ADA) LAUNDRY ROOM-FIRST FLO TOTAL NEW WATER FIXTURE BUILDING TOTAL WATER BUILDING TOTAL WATER	LATION: IS — LATION: IS — LATION: IS — NUMBER FIXTURES 22 23 R'S 1 1 OR 1 E UNITS R FIXTURE	NUMBER OF FIXTURES 1 NUMBER OF FIXTURES 2 1 NUMBER OF FIXTURES 1 NUMBER OF X X X X X X X X X X X X X	X X X X X X X FIXTURE UNITS 1.5 1.5 1.5 1.5 1.5 9.5	FIXTURE UNITS 1.5 FIXTURE UNITS 4 1.5 FIXTURE UNITS 4 1.5	TOTAL FIXTULUNITS 33 34.! 15.3 1.5 9.: 99:	TOTAL FIXTURE UNITS 1.5 1.5 1.5 1.5 1.5 1.5 1.5 1.

3.5 <u>TOTAL</u>		-		
FIXTURE TOTAL FIXTURE UNITS $4 = 8$ $1.5 = 1.5$ $9.5 TOTAL$				
FIXTURE TOTAL FIXTURE FIXTURE UNITS = UNITS 1.5 = 1.5 1.5 TOTAL				
TOTAL FIXTURE UNITS = 33 = 34.5 = 15.3 = 1.5 = 3.5 = 9.5 = 9.5 99 TOTAL	PROJECT RESIDENTIAL AREA HOT	WATER CALCULATION		
TOTAL FIXTURE UNITS = 363.5 = 99	FIXTURES OTY SHOWER STALL 1 LAVATORY 2 KITCHEN SINK 47 CLOTHES WASHER 3 HAND SINK 2 TOTAL HOT WATER GPH —	H.W.(F.U.) GPH EACH 2 30 2 2 70.5 10 12 20 3 10 97.5	30 100% 4 100% 470 30%	= TOTAL% = 30 = 4 = 141 = 30 = 6 215 TOTAL
	2. NEW WATER HEATER	/ GA. X 80/0.96 = 149 MODEL BTH-150A, 150,00	·	

RESIDENTIAL COLD WATER DESIGN STREET MAIN TO PRV/LAST OUTLET CONTACT: CALIFORNIA WATER SERVICE COMPANY (NATALIE) PHONE: 831-385-5486 (A) PRESSURE AVAILABLE: 72 PSI (STATIC) (B) WATER HARDNESS: ____GR./GAL. (C) TOTAL FIXTURE UNITS: (FLUSH TANK) <u>95</u> F.U. (D) WATER DEMAND: _42 GPM 20.0 PSI (E) RESIDUAL PRESSURE REQUIRED AT FARTHEST OUTLET: (F) PRESSURE LOSS DUE TO HEIGHT 24 FT. x 0.433: 10.4 PSI (G) PRESSURE LOSS THRU _ WATER METER: __<u>6.4</u> PSI (H) PRESSURE LOSS THRU 4" BACKFLOW PREVENTER: 15.0 PSI N/A PSI (I) TOTAL PRESSURE LOSS THRU ____PRESSURE REGULATION: N/A PSI (J) TOTAL PRESSURE LOSS THRU - SUBMETER: 51.8 PSI (K) TOTAL PRESSURE LOSS FROM ABOVE (ITEM E, THRU I): (L) MINIMUM PRESSURE AVAILABLE: (ASSUME MINIMUM 60 PSI) <u>60</u> PSI _8.2_ PSI (M) PRESSURE AVAILABLE FOR FRICTION LOSS (L-K): (N) DEVELOPED PIPE LENGTH: 500 FT. 1. LENGTH OF RUN (MAIN TO LAST FIXTURE): 2. EQUIVALENT LENGTH OF FITTINGS (25%): <u>125</u> FT. _625_ FT. 3. TOTAL DEVELOPED LENGTH: (O) FRICTION LOSS PER ONE HUNDRED (100) FEET OF PIPE: 1: 100' x (M) 8.2 DIVIDED BY (N) 625 = 1.3 PSI/100' PIPE SIZES BASED ON TYPE "L" COPPER @ 1.1 PSI/100 FT. C.W. VELOCITY NOT TO EXCEED 8 FT. PER SECOND. & 5 FT. PER SECOND H.W.

		CC	PPER	PIPE S	SIZING	<u>CHART</u>	<u>'S</u>		
	(COLI	D WAT	ER)						
DIS	TRIBUTIO	ON PIPE	SIZINO	CHAR	I				
1.1_1	PSI/100	FT MA	XIMUM	FRICTIO	N LOSS				
MAX	IMUM V	ELOCITY	OF 6	FEET/	SECONE	2			
PIPE SIZE	1/2"	3/4"	1"	1-1/4"	1-1/2"	2"	2-1/2"	3"	4"
GPM		3	5	9	15	31	55	88	185
FU	_	2	6	13	21	58	165	337	874
FV					-	15	69	205	850
VEL	-	_	_	_	-		_	_	_
	<u>(HOT</u>	WATE	R)						
1.1	TRIBUTIO	ON PIPE	SIZINO XIMUM	FRICTIO	N LOSS				
1.1_I MAX	TRIBUTIO	ON PIPE	SIZINO XIMUM OF 5	FRICTIO	N LOSS SECONI	2	2-1/2"	3"	4"
1.1 I MAX PIPE SIZE	TRIBUTIO	ON PIPE FT MAX	SIZINO XIMUM OF 5	FRICTIO FEET/	N LOSS SECONI	2	2-1/2" 55	3" 88	4" 185
1.1 I MAX PIPE SIZE	TRIBUTIO	FT MA ELOCITY 3/4"	SIZING XIMUM ' OF 5	FRICTIO FEET/ 1-1/4"	N LOSS SECONI 1-1/2"	2"			
1.1_I MAX PIPE SIZE GPM	TRIBUTIO	FT MA FLOCITY 3/4"	SIZING XIMUM OF 5 1" 5	FRICTIO FEET/ 1-1/4" 9	N LOSS SECONE 1-1/2" 15	2" 31	55	88	185
1.1_I MAX PIPE SIZE GPM	TRIBUTIO	FT MA FLOCITY 3/4"	SIZING XIMUM OF 5 1" 5	FRICTIO FEET/ 1-1/4" 9	N LOSS SECONE 1-1/2" 15	2" 31	55	88	185

	(COLD WATER)											
DIST	DISTRIBUTION PIPE SIZING CHART											
1.1 P	1.1 PSI/100 FT MAXIMUM FRICTION LOSS											
MAX	MAXIMUM VELOCITY OF 6 FEET/ SECOND											
	FLOWGUARD GOLD SDR11 "CORZAN" CPVC SCH. 80 "CHARLOTTE" L.A. TEST LAB # RR-5697 "HARVEL" L.A. TEST LAB # RR-5695											
PIPE SIZE	3/4"	1"	1-1/4"	1-1/2"	2"	2-1/2'	3"	4"				
GPM	2	4	7	11	23	50	90	180				
FT FU	1	4	8	15	36	127	326	809				
FV FU	_	-		_	6	55	224	800				
VEL	-	-	•••	-		_						

<u></u>	CPVC PIPE SIZING CHARTS											
		IOT WA					·	"				
DISTRIBUTION PIPE SIZING CHART												
	.0 PSI/100 FT MAXIMUM FRICTION LOSS											
MAXIMUM VELOCITY OF 6 FEET/ SECOND												
	"Cl	FLOWGUA FLOTTE	RD GOLD L.A. TES	SDR11 T LAB # 1	RR-5697	"CORZA "HARVEL"	N" CPVC LA. TES	SCH. 80 TLAB#F	R-5695			
PIPE SIZE	3/4"	1"	1-1/4"	1-1/2"	2"	2-1/2	3"	4"				
GPM	2	4	7	11	23	50	90	180				
FT FU	1	4	8	15	36	127	326	809				
FV FU	-						-	_				

NOTICE

This document is confidential, incorporating proprietary rights. Any party accepting this document agrees that it shall not be duplicated in whole or in part, nor disclosed to others without the express consent of John Tennant General Building Contractor, Inc.

AYS INN KING

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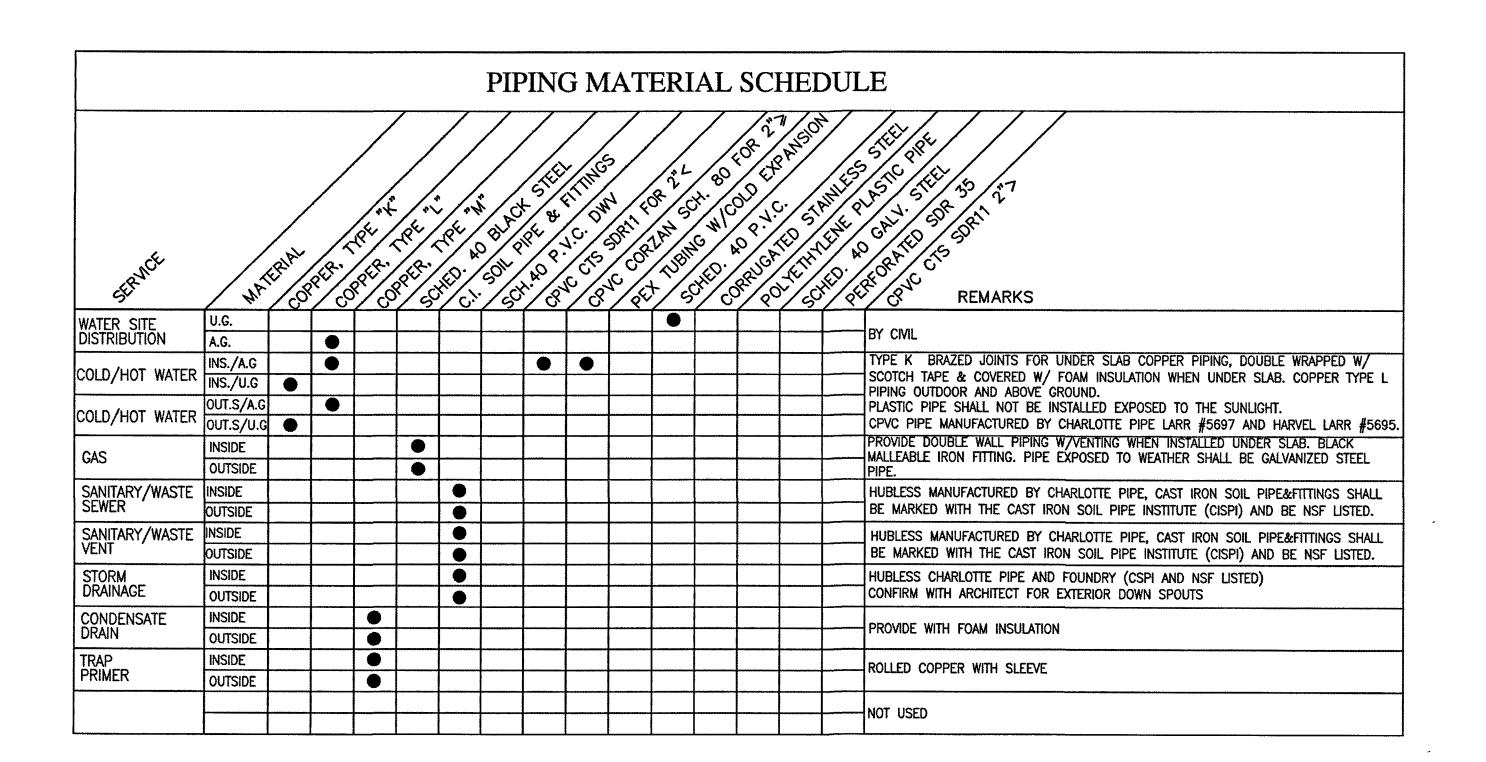


DESCRIP1	TION	DATE
MEP REVI	SION	02/28/2023
JOB.		,,,,,,,,,,,,,,,,,,,,,,,,,,,,,,,,,,,,,,
SCALE [,]	AS SHOWN	
DRAWN.		
DATE.		02/2

PLUMBING CALCULATION

SHEET NO:

P1.1



PIPING MATERIAL SCHEDULE

SCALE 2

NOT USED

PLUMBING EQUIPMENT SCHEDULE

GENERAL:

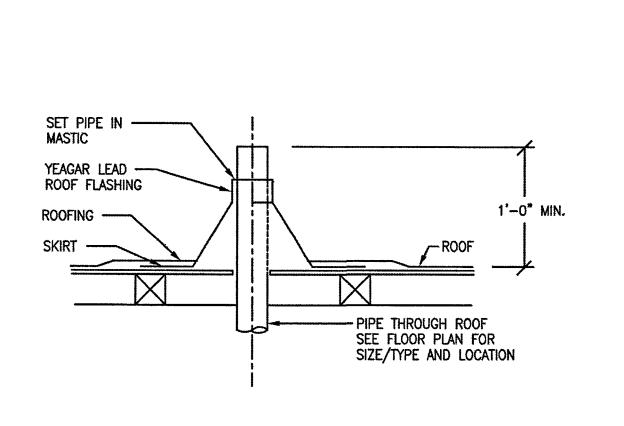
- ① ALL PLUMBING FIXTURES TO BE WHITE AND TRIM TO BE POLISHED CHROME FINISH UNLESS NOTED OTHERWISE.
- PROVIDE BRASSCRAFT KWIK TURN ANGLE STOPS FOR ALL FIXTURES.
- 3 PLUMBING FIXTURES AND TRIM SHALL BE AS NOTED OR EQUAL AND APPROVED BY OWNER.
- (4) ALL HANDICAP LAVATORY & SINK TO BE PROVIDED WITH INSULATION FOR THE DRAIN & HOT WATER PIPING AS TRUEBRO KIT # 101 INSULATION KIT OR EQUAL.
- (5) ALL PLUMBING FIXTURES TO BE APPROVED FOR USE IN KING CITY.
- (6) ALL PLUMBING FIXTURES MATERIAL, IAPMO LIST. MUST MEET WATER CONSERVATION ORDINANCE, MEET LOW LEAD REQUIREMENT (LESS THAN 0.25% WEIGHTED AVERAGE)
- ALL PLUMBING FIXTURES SHALL MEET THE FLOW REQUIREMENTS SPECIFIED BY THE LOCAL AUTHORITY HAVING JURISDICTION.
- (8) COORDINATE WITH THE ARCHITECT AND OWNERSHIP FINAL SPECIFICATION AND SIZES OF PLUMBING FIXTURES.
- ② CLOTHES WASHERS AND DISHWASHERS SHALL BE ENERGY STAR CERTIFIED.

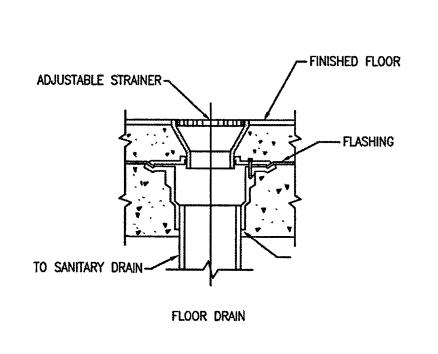
 ② PLUMBING FIXTURES SHALL COMPLY WITH 2019 CPC AND MEET THE APPLICABLE STANDARDS IN TABLE 1701.1.

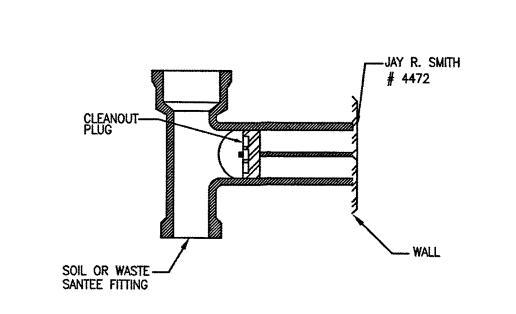
			PING C	1	T	FIXTUR		
ITEM	FIXTURE/ EQUIPMENT	SOIL OR WASTE	VENT	COLD WATER	HOT WATER	WASTE F.U.	COLD WATER F.U.	DESCRIPTION
WC-1	WATER CLOSET (PRIVATE)	3"	2"	1"	-	3	2.5	SEE ARCHITECTURAL DRAWINGS - FOR PRODUCT SPECIFICATION AND MANUFACTURER MODEL NUMBER. THE MAXIMUM FLOW RATES FOR WATER CLOSETS, URINALS, LAVATORIES, KITCHEN FAUCETS, AND SHOWER HEADS SHALL BE IN COMPLIANCE WITH CALGREEN BUILDING CODE.
WC-2	WATER CLOSET (PUBLIC)	3"	2"	1"	_	4	2.5	WATER CLOSET SPECIFICATIONS BY ARCHITECT. FLOW RATE SHALL BE 1.28 GPF OR LESS.
L-1	LAVATORY (PRIVATE)	2"	1½"	3/4"	3/4"	1	1	LAVATORY SPECIFICATIONS BY ARCHITECT. LAVATORY FAUCET FLOW RATE SHALL BE 1.2 GPM OR LESS. PUBLIC LAVATORY FAUCET SHALL BE 0.4 GPM OR LESS, OR METERING FAUCET OF 0.17 GPC OR LESS. PROVIDE THERMOSTATIC MIXING VALVE FOR PUBLIC LAVATORY FAUCET.
L-2	LAVATORY (PUBLIC)	2"	1½"	3/4"	3/4"	1	1	KITCHEN SINK AND SINK FAUCETS SHALL BE 1.5 GPM OR LESS AT 60 PSI.
					·			KITCHEN SINK WITH GARBAGE DISPOSAL BADGER 5XP, 3/4HP, 120 VOLTS.
⟨S−1	KITCHEN SINK (PRIVATE)	2"	1½"	1"	1"	2	1.5	SHOWER HEAD SHALL BE 1.5 GPM OR LESS AT 80 PSI.
	(I MANL)							BATHTUB/SHOWER SHALL HAVE INDIVIDUAL SHOWER CONTROL VALVE OF THE PRESSUR BALANCE OR THERMOSTATIC MIXING VALVE TYPE, SET AT 120 DEGREE F MAXIMUM.
SH-1	SHOWER STALL (ADA)	2"	1½"	1"	1"	2	2	2" MIXING VALVE INLET CONNECTIONS.
	(NUA)							SHOWER HEAD FLOW RATE SHALL BE 1.8 GPM OR LESS AT 80 PSI, PRESSURE BALANCE SHOWER MIXING VALVE WITH SHOWER HEAD AND INTEGRAL STOPS. \(\}^* \) MIXING
								VALVE INLET CONNECTIONS.
								PUBLIC WATER CLOSET SHALL HAVE OPEN FRON SEAT.
WHA	WATER HAMMER ARRESTOR	-		-	AA	***		PRECISION PLUMBING PRODUCTS WATER HAMMER ARRESTORS, HYDRAULIC DISPLACEMENT, PERMANENTLY SEALED, PISTON OPERATED, SIZED IN ACCORDANCE TO SCHEDULE: MODEL # FIXTURE UNIT RATING.P.S. ACCESS PANEL KARP #214M SC-500 1-11 1/2" 12"x12" SC-750 12-32 3/4" 12"x12" SC-100 33-60 1" 12"x12" SC-100 61-113 1-1/4" 12"x12"
								PROVIDE STAINLESS STEEL ACCESS PANEL IN TILED WALLS & ALL PUBLIC RESTROOM CONFIRM FINISH OF ALL OTHER ACCESS PANEL WITH ARCHITECT
WB-1	WASHING MACHINE BOX	2"	1½"	_	-	3		OATEY MODA RECESSED LAUNDRY BOX; 37609, 37611, 37613, 37610 DEPENDING ON PIPING. WITH WATER HAMMER ARRESTORS, 1/4 TURN SHUTOFFS & 2" WASTE OUTLET PROVIDE ONE PER MACHINE & 12"x12" STAINLESS STEEL ACCESS PANEL FOR 2" TR CLOTHES WASHER SHALL BE ENERGY STAR CERTIFIED.
FD-1	FLOOR DRAIN	3"	2"		-	3	_	J.R. SMITH #2005-A DUCO CAST IRON BODY & FLASHING COLLAR WITH PROTECTOR CAP AND 5" ROUND ADJUSTABLE STRAINER HEAD, BOTTOM OUTLET WITH TRAP PRIMER CONNECTION.
TP-1	TRAP PRIMER	••••		1/2"			•	PRECISION PLUMBING PRODUCTS MODEL # P-2 WITH SHUT-OFF VALVE AND 12" x 12" ACCESS PANEL AS KARP MODEL # 214MSS PROVIDE STAINLESS STEEL ACCESS PANEL IN TILED WALLS & ALL PUBLIC BATHROOMS CONFIRM FINISH OF ALL OTHER ACCESS PANEL WITH ARCHITECT
FCO	FLOOR CLEANOUT	SEE PLANS	-	_	_	_		J.R. SMITH #4020S IRON BODY, ABS PLUG WITH BRONZE COVER WITH GASKET.
S - 1	HAND SINK	2"	11/2"	1"	1"	2	1.5	SPECIFICATIONS BY ARCHITECT.

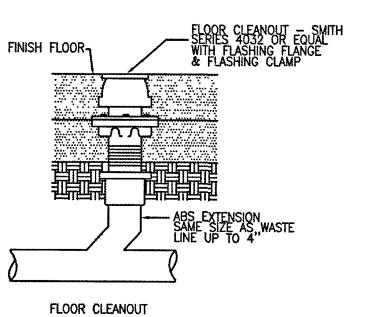
PLUMBING EQUIPMENT SCHEDULE

SCALE 1









PLUMBING SCHEDULE AND DETAILS

AS SHOWN

SHEET NO

P1.2

WASTE & VENT PIPE THRU ROOF DETAIL SCALE (5)

FLOOR DRAIN DETAIL

SCALE 4

FLOOR AND WALL CLEANOUT DETAIL

scale none

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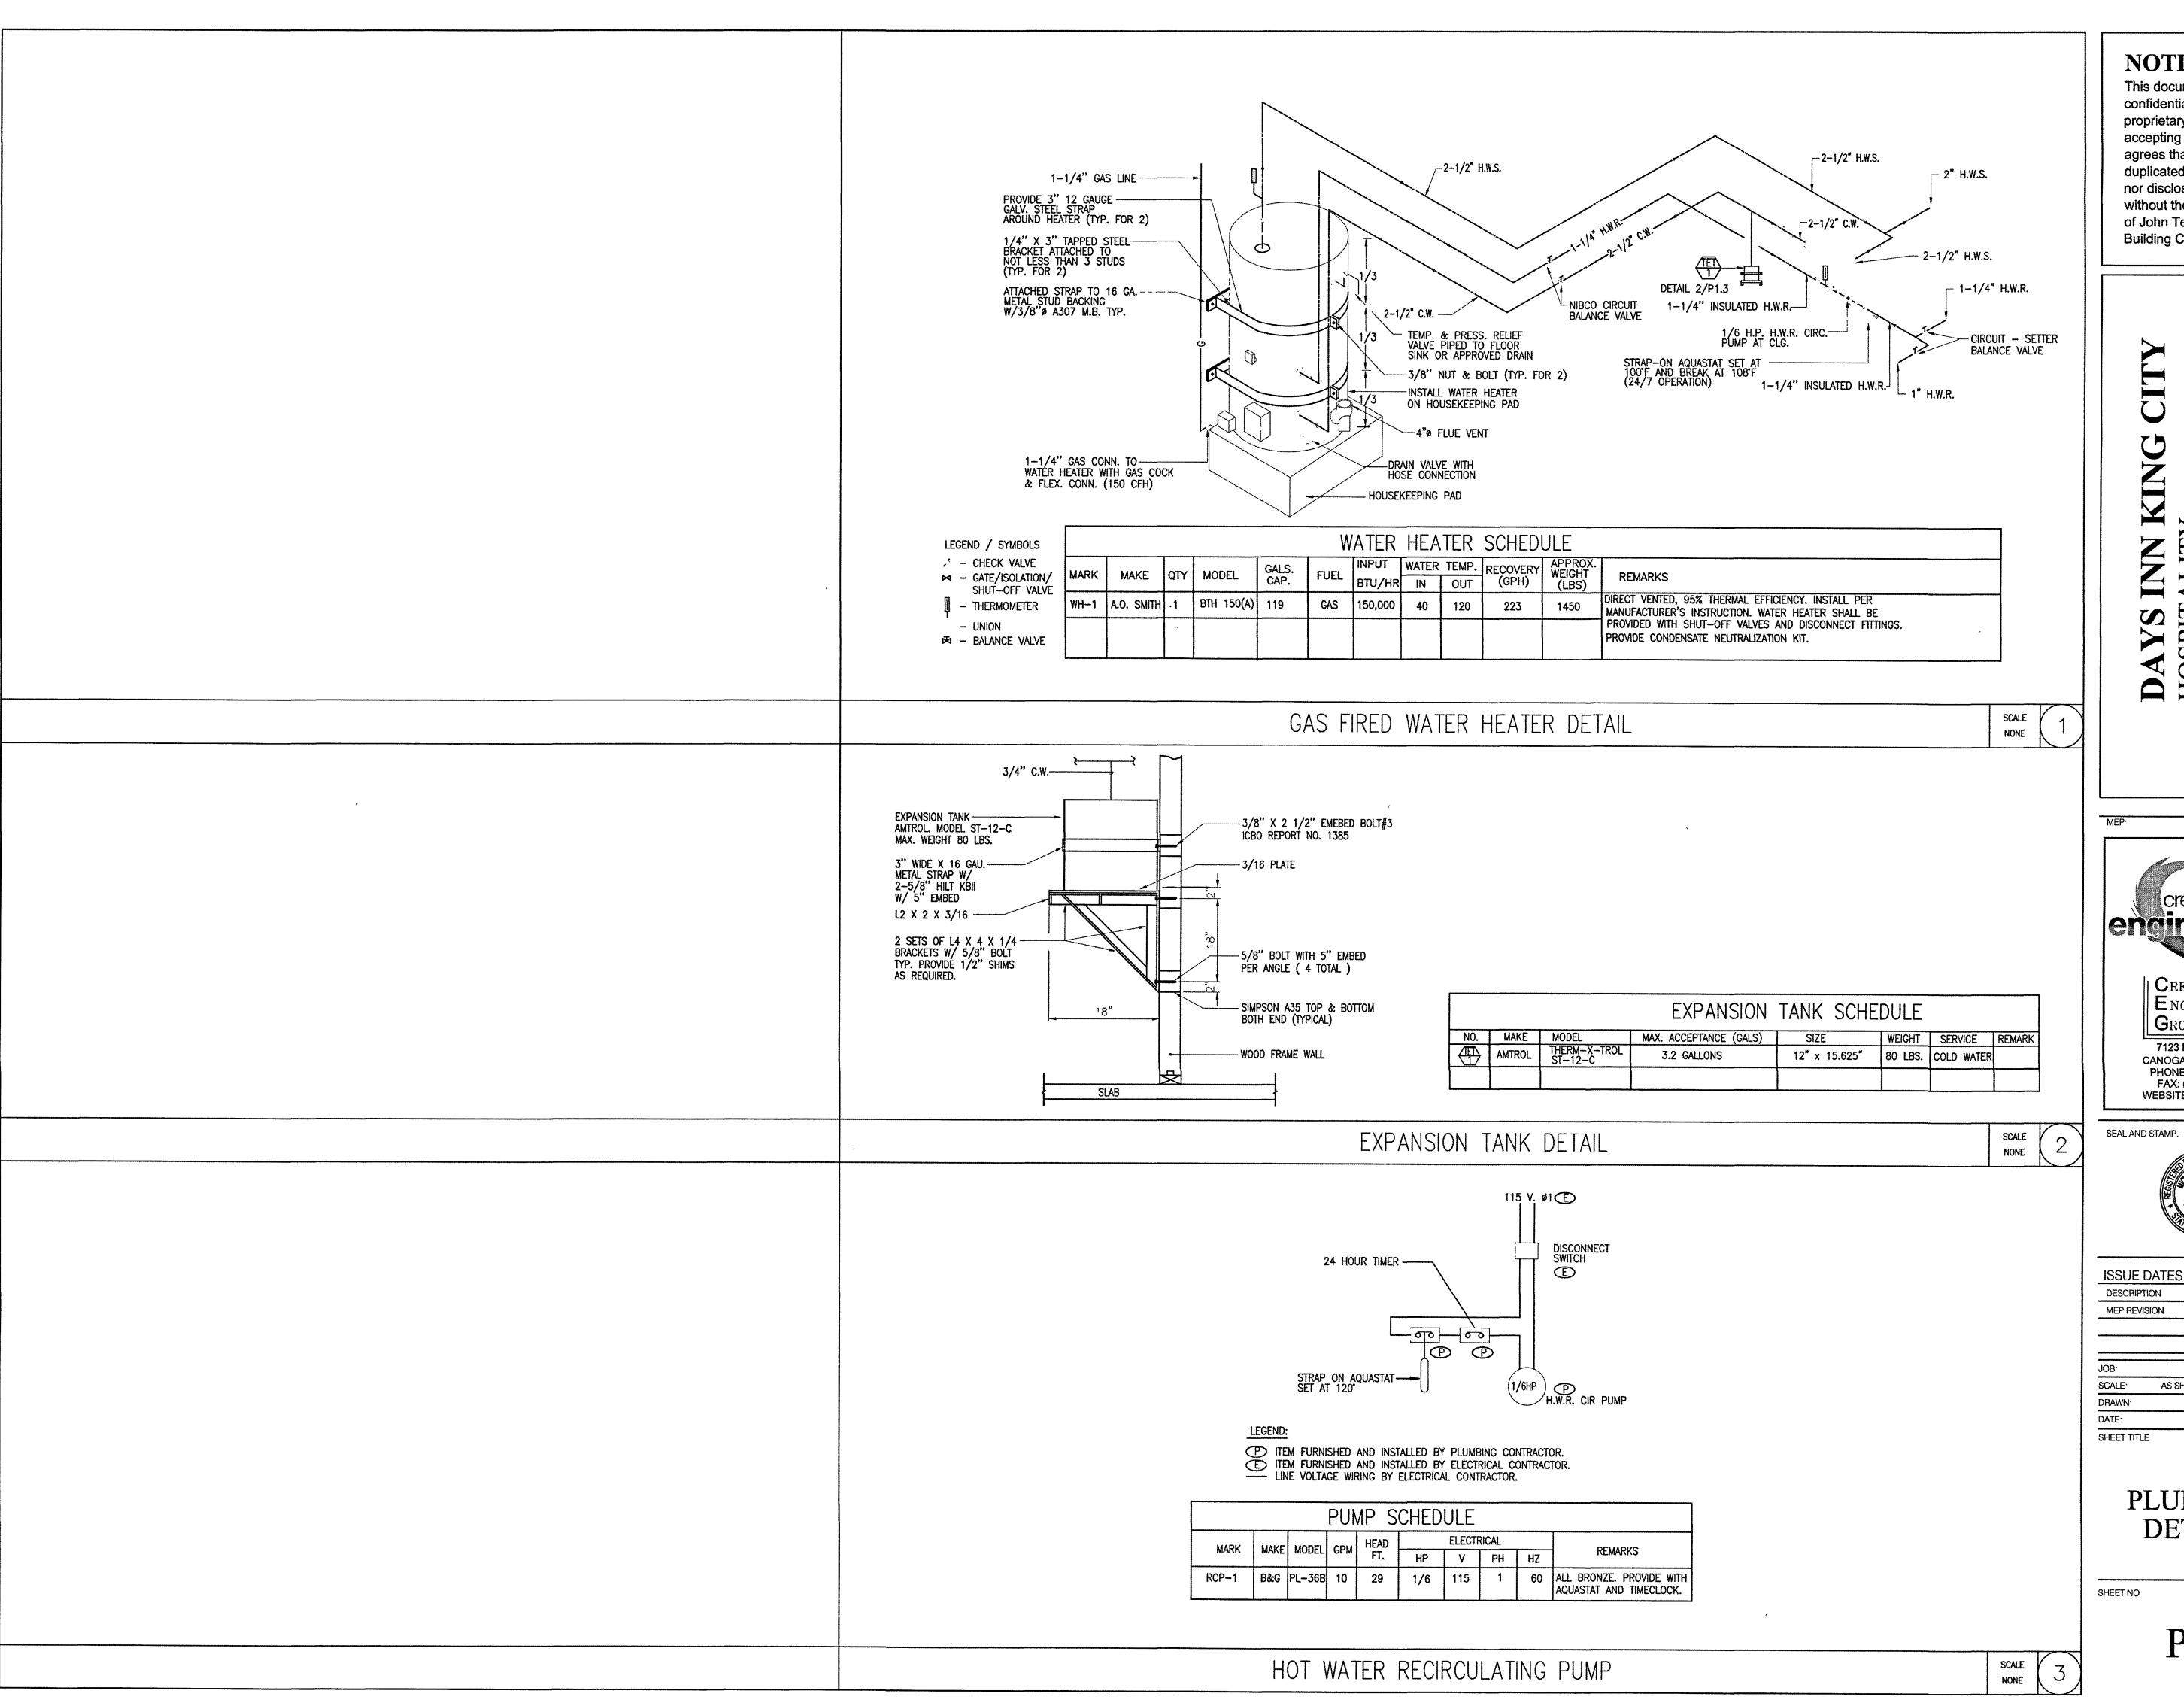
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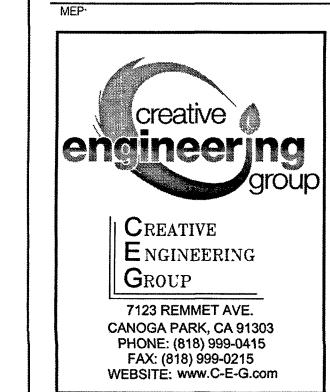


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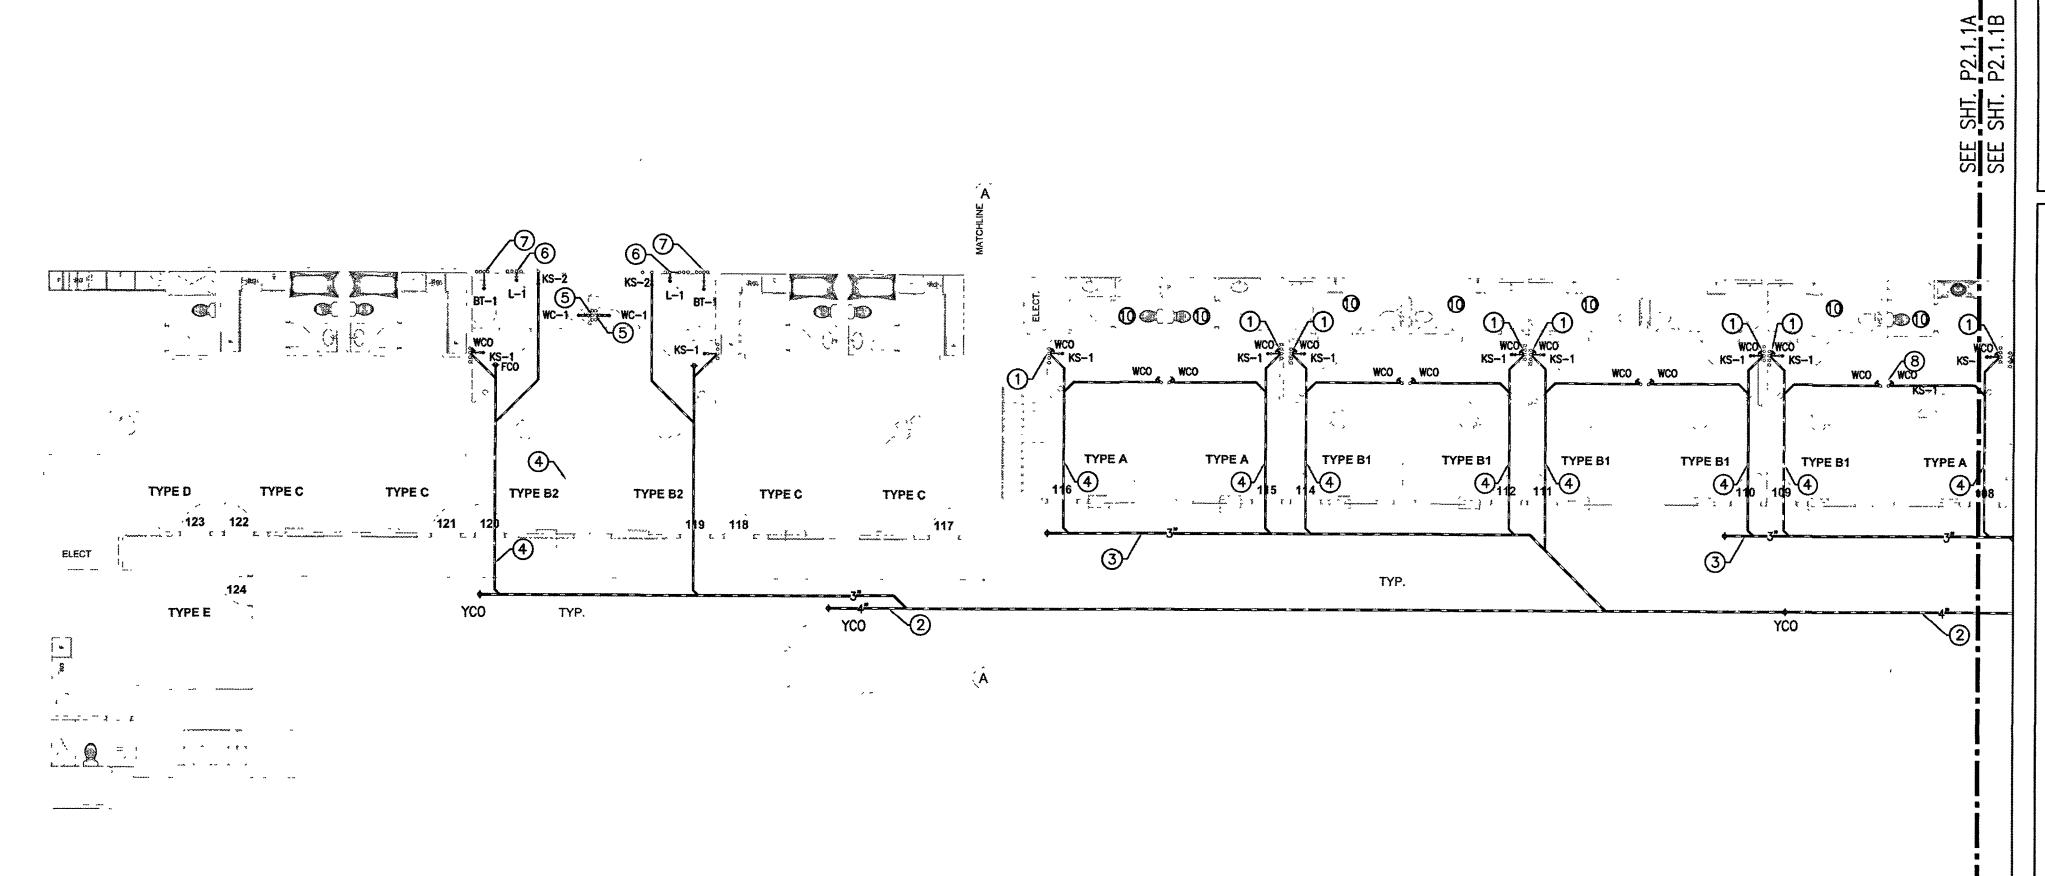




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PLUMBING DETAILS

P1.3



(E) MANHOLE. CONTRACTOR TO VERIFY ON SITE EXACT LOCATION

PLUMBING ENLARGED PARTIAL FIRST FLOOR WASTE AND VENT PLAN SCALE: 1/8"=1'-0"

PLUMBING REFERENCE NOTES

- (N) 4" WASTE BELOW GRADE & CONNECT TO NEAREST (E) 6" WASTE IF POSSIBLE, OR CONNECT TO (E) MANHOLE. CONTRACTOR TO VERIFY ON SITE EXACT LOCATION, SIZE, ELEVATION OF (E) 6" WASTE, OR LOCATION OF EXISTING MANHOLE.
- ② (N) 4" WASTE BELOW GRADE & SLOPE @ 1%.
- (N) 3" WASTE BELOW GRADE & SLOPE @ 2%.
- (A) (N) 2" WASTE BELOW GRADE & SLOPE @ 2%.
- (5) (N) WATER CLOSET TO NEW LOCATION. PROVIDE NEW PIPING (COLD WATER, WASTE, & VENT AND CONNECT TO (E) PIPING OF REMOVED (E) WATER CLOSET.
- (6) (N) LAVATORY TO NEW LOCATION. PROVIDE NEW PIPING (COLD WATER, HOT WATER, WASTE, & VENT AND CONNECT TO (E) PIPING OF REMOVED (E) WATER CLOSET.
- (N)TUB/SHOWER COMBO. PROVIDE NEW PIPING (COLD WATER, HOT WATER, WASTE, & VENT AND CONNECT TO (E) PIPING OF REMOVED (E) TUB/SHOWER. COORDINATE WITH ARCHITECT THE EXACT LOCATION OF SHOWER HEAD AND CONTROL VALVES.
- (N) 2" WASTE DOWN & 1-1/2" VENT UP THRU ROOF. (TYPICAL FOR KITCHEN SINK)
- PROVIDE ACCESSIBLE CLEANOUT.
- PROVIDE NEW PIPING AND CONNECT IT TO EXISTING

GENERAL NOTES

- (1) WASTE PIPING BELOW GROUND TO BE CAST IRON.
- WASTE & VENT PIPING ABOVE GROUND TO BE CAST IRON.
- 3 USE SOUND ISOLATION BRACKETS FOR WATER PIPING.
- PROVIDE INSULATION FOR TRAPS ON ALL ADA ACCESS FIXTURES.

 5 PROVIDE ANGLE STOPS FOR EACH INDIVIDUAL FIXTURE.
- 5 SEE ARCHITECTURAL DRAWINGS FOR EXACT DIMENSIONS.

 7 SEE WASTE & VENT, GAS, HOT & COLD WATER PIPING RISER DIAGRAMS.
- (8) SEE PLUMBING SITE PLAN AND CIVIL DRAWINGS.
- 9 CONNECT VENTS IN ROOF ATTIC SPACE & VERIFY EXACT LOCATIONS OF ROOF PENETRATIONS WITH ARCHITECT.
- LOWER ROUGH-IN HEIGHTS FOR ALL ADA & ADAPTABLE KITCHENS.
- VERIFY ON SITE EXACT LOCATION OF MANHOLE.

PLUMBING CONTRACTOR SHALL CARRY ALLOWANCE TO PROVIDE A COMPLETE PLUMBING SYSTEM FOR ALL AREAS INCLUDING PLUMBING FIXTURE ROUGH—IN AND ALL UTILITY PIPES.

ALL REQUIRED CLEANOUTS SHALL BE INSTALLED AS PER SECTION 707.0 & 719.0 OF THE CALIFORNIA PLUMBING CODE, 2019.

PLUMBING CONTRACTOR SHALL PROVIDE ROUGH-INS, EXTEND ALL PIPING (WASTE, VENT, COLD WATER, HOT WATER, ETC.) TO ALL FIXTURES AS INDICATED ON THE ARCHITECTURAL DRAWINGS.

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PLUMBING ENLARGED PARTIAL FIRST FLOOR WASTE & VENT PLAN

SHEET NO:

P2.1.1A

, COMPUTER ROOM

PLUMBING ENLARGED PARTIAL FIRST FLOOR WASTE AND VENT PLAN SCALE: 1/8"=1'-0"

PLUMBING REFERENCE NOTES ① (N) 4" WASTE BELOW GRADE & SLOPE @ 1%. ② (N) 3" WASTE BELOW GRADE & SLOPE @ 2%. ③ (N) 2" WASTE BELOW GRADE & SLOPE @ 2%. ④ (N) 3" WASTE BELOW GRADE & SLOPE @ 2%. ④ (N) 3" WASTE DOWN & 2" VENT UP THRU ROOF. (TYPICAL FOR WATER CLOSET & MOP SINK) ⑤ (N) 2" WASTE DOWN & 1-1/2" VENT UP THRU ROOF. (TYPICAL FOR LAVATORY) ⑥ (N) 2" WASTE DOWN & 1-1/2" VENT UP THRU ROOF. (TYPICAL FOR SHOWER STALL) ⑦ (N) 2" WASTE DOWN & 1-1/2" VENT UP THRU ROOF. (TYPICAL FOR KITCHEN SINK) ③ (N) 2" WASTE DOWN & 1-1/2" VENT UP THRU ROOF. (TYPICAL CLOTHES WASHER) ④ (N) 2" WASTE DOWN & 1-1/2" VENT UP THRU ROOF.

PROVIDE ACCESSIBLE CLEANOUT.

O CONNECT GARBAGE DISPOSAL TO SINK & CONNECT

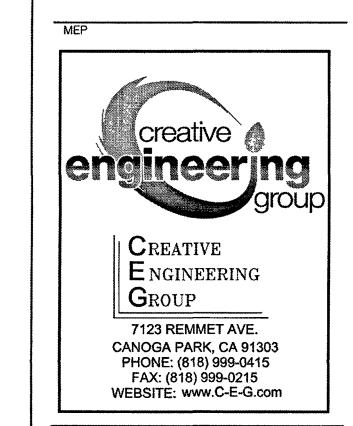
DISHWASHER TO GARBAGE DISPOSAL THROUGH APPROVED LEDGE MOUNTED AIR GAP FITTING ON SINK.

GENERAL NOTES	
WASTE PIPING BELOW GROUND TO BE CAST IRON. WASTE & VENT PIPING ABOVE GROUND TO BE CAST IRON. USE SOUND ISOLATION BRACKETS FOR WATER PIPING. PROVIDE INSULATION FOR TRAPS ON ALL ADA ACCESS FIXTURES. PROVIDE ANGLE STOPS FOR EACH INDIVIDUAL FIXTURE. SEE ARCHITECTURAL DRAWINGS FOR EXACT DIMENSIONS. SEE WASTE & VENT, GAS, HOT & COLD WATER PIPING RISER DIAGRAMS. SEE PLUMBING SITE PLAN AND CIVIL DRAWINGS. CONNECT VENTS IN ROOF ATTIC SPACE & VERIFY EXACT LOCATION OF ROOF PENETRATIONS WITH ARCHITECT. LOWER ROUGH—IN HEIGHTS FOR ALL ADA & ADAPTABLE KITCHENS VERIFY ON SITE EXACT LOCATION OF MANHOLE.	PLUMBING CONTRACTOR SHALL CARRY ALLOWANCE TO PROVIDE A COMPLETE PLUMBING SYSTEM FOR ALL AREAS INCLUDING PLUMBING FIXTURE ROUGH—IN AND ALL UTILITY PIPES. ALL REQUIRED CLEANOUTS SHALL BE INSTALLED AS PER SECTION 707.0 & 719.0 OF THE CALIFORNIA PLUMBING CODE, 2019. PLUMBING CONTRACTOR SHALL PROVIDE ROUGH—INS, EXTEND ALL PIPING (WASTE, VENT, COLD WATER, HOT WATER, ETC.) TO ALL FIXTURES AS INDICATED ON THE ARCHITECTURAL DRAWINGS.

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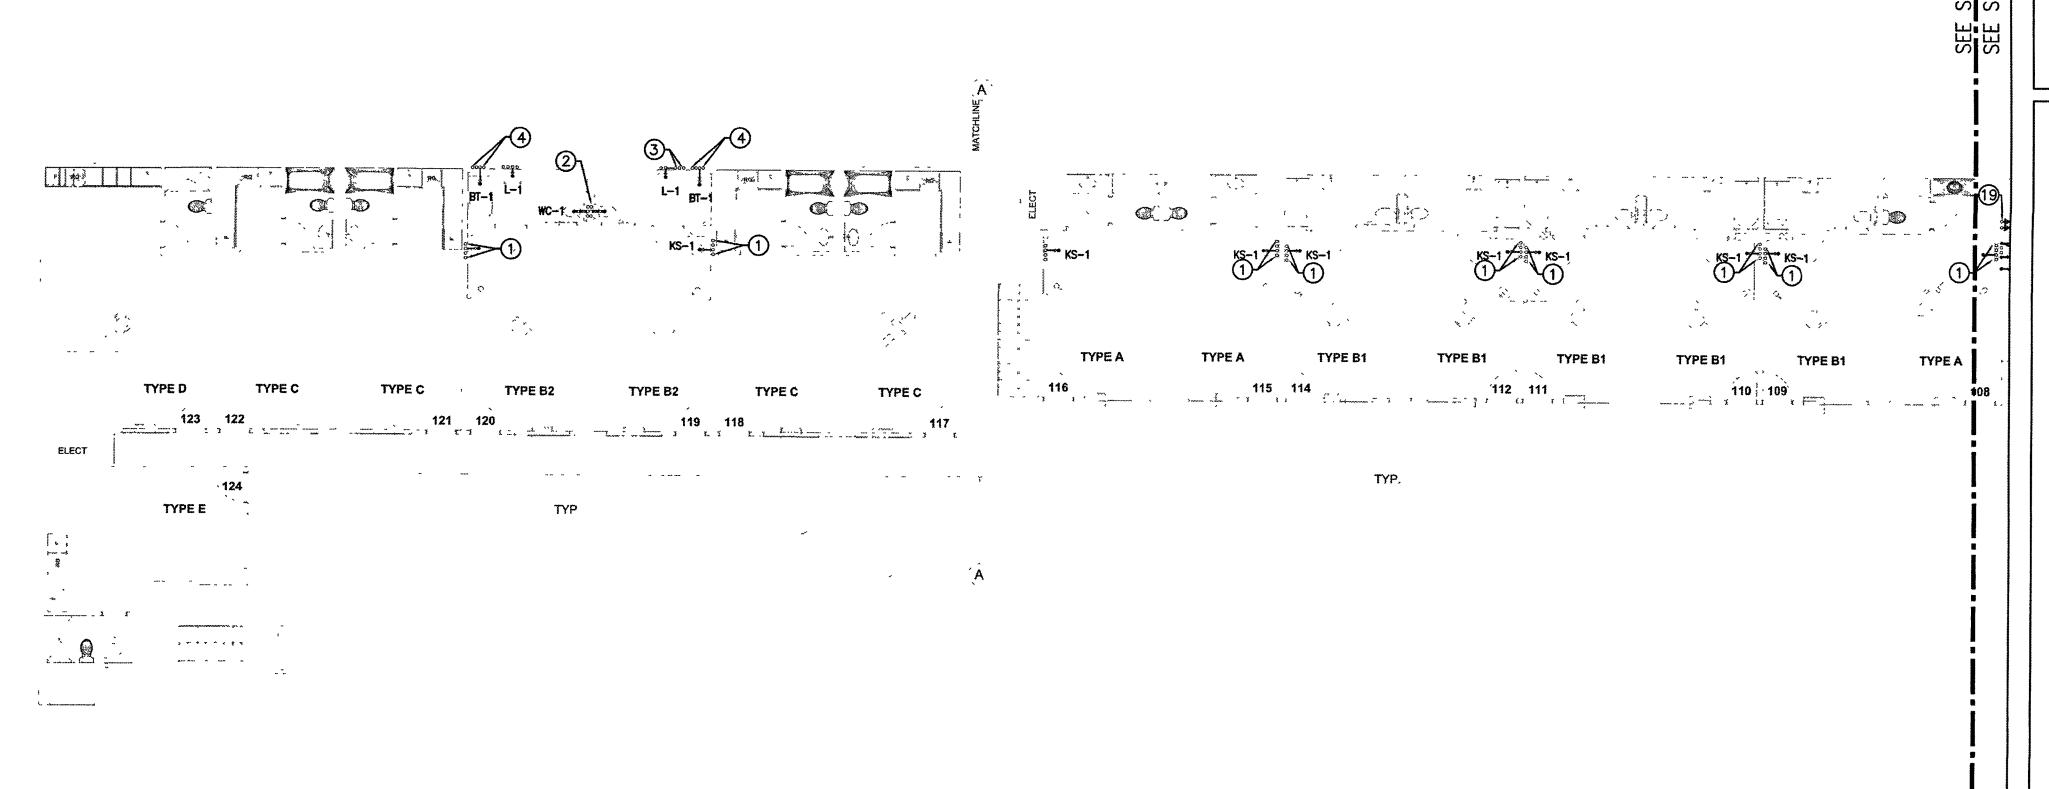
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(E) MANHOLE. CONTRACTOR TO VERIFY ON SITE EXACT LOCATION

PLUMBING ENLARGED PARTIAL FIRST FLOOR WATER AND GAS PLAN SCALE: 1/8"=1'-0"

PLUMBING REFERENCE NOTES

- 1" COLD WATER & 1" HOT WATER SUPPLY FROM ABOVE & DOWN TO KITCHEN SINK. SEE HOT & COLD WATER RISER DIAGRAMS. (TYPICAL)
- ② EXTEND COLD WATER PIPING FROM REMOVED (E) WATER CLOSET.
- 3 EXTEND HOT & COLD WATER PIPING FROM REMOVED (E) LAVATORY.
- EXTEND HOT & COLD WATER PIPING FROM REMOVED (E) TUB/SHOWER.
 REFER TO ARCHITECT & ADA REQUIREMENTS OF EXACT LOCATION OF SHOWER HEAD, VALVES, AND CONTROLS.

GENERAL NOTES

- WASTE PIPING BELOW GROUND TO BE CAST IRON.
- 2 WASTE & VENT PIPING ABOVE GROUND TO BE CAST IRON.
 3 USE SOUND ISOLATION BRACKETS FOR WATER PIPING.
- PROVIDE INSULATION FOR TRAPS ON ALL ADA ACCESS FIXTURES.
- 5> PROVIDE ANGLE STOPS FOR EACH INDIVIDUAL FIXTURE.
- 6 SEE ARCHITECTURAL DRAWINGS FOR EXACT DIMENSIONS.
- SEE WASTE & VENT, GAS, HOT & COLD WATER PIPING RISER DIAGRAMS.
- 8 SEE PLUMBING SITE PLAN AND CIVIL DRAWINGS.
- 9 CONNECT VENTS IN ROOF ATTIC SPACE & VERIFY EXACT LOCATIONS OF ROOF PENETRATIONS WITH ARCHITECT.
- LOWER ROUGH-IN HEIGHTS FOR ALL ADA & ADAPTABLE KITCHENS.
- VERIFY ON SITE EXACT LOCATION OF MANHOLE.

PLUMBING CONTRACTOR SHALL CARRY ALLOWANCE TO PROVIDE A COMPLETE PLUMBING SYSTEM FOR ALL AREAS INCLUDING PLUMBING FIXTURE ROUGH—IN AND ALL UTILITY

ALL REQUIRED CLEANOUTS SHALL BE INSTALLED AS PER SECTION 707.0 & 719.0 OF THE CALIFORNIA PLUMBING CODE, 2019.

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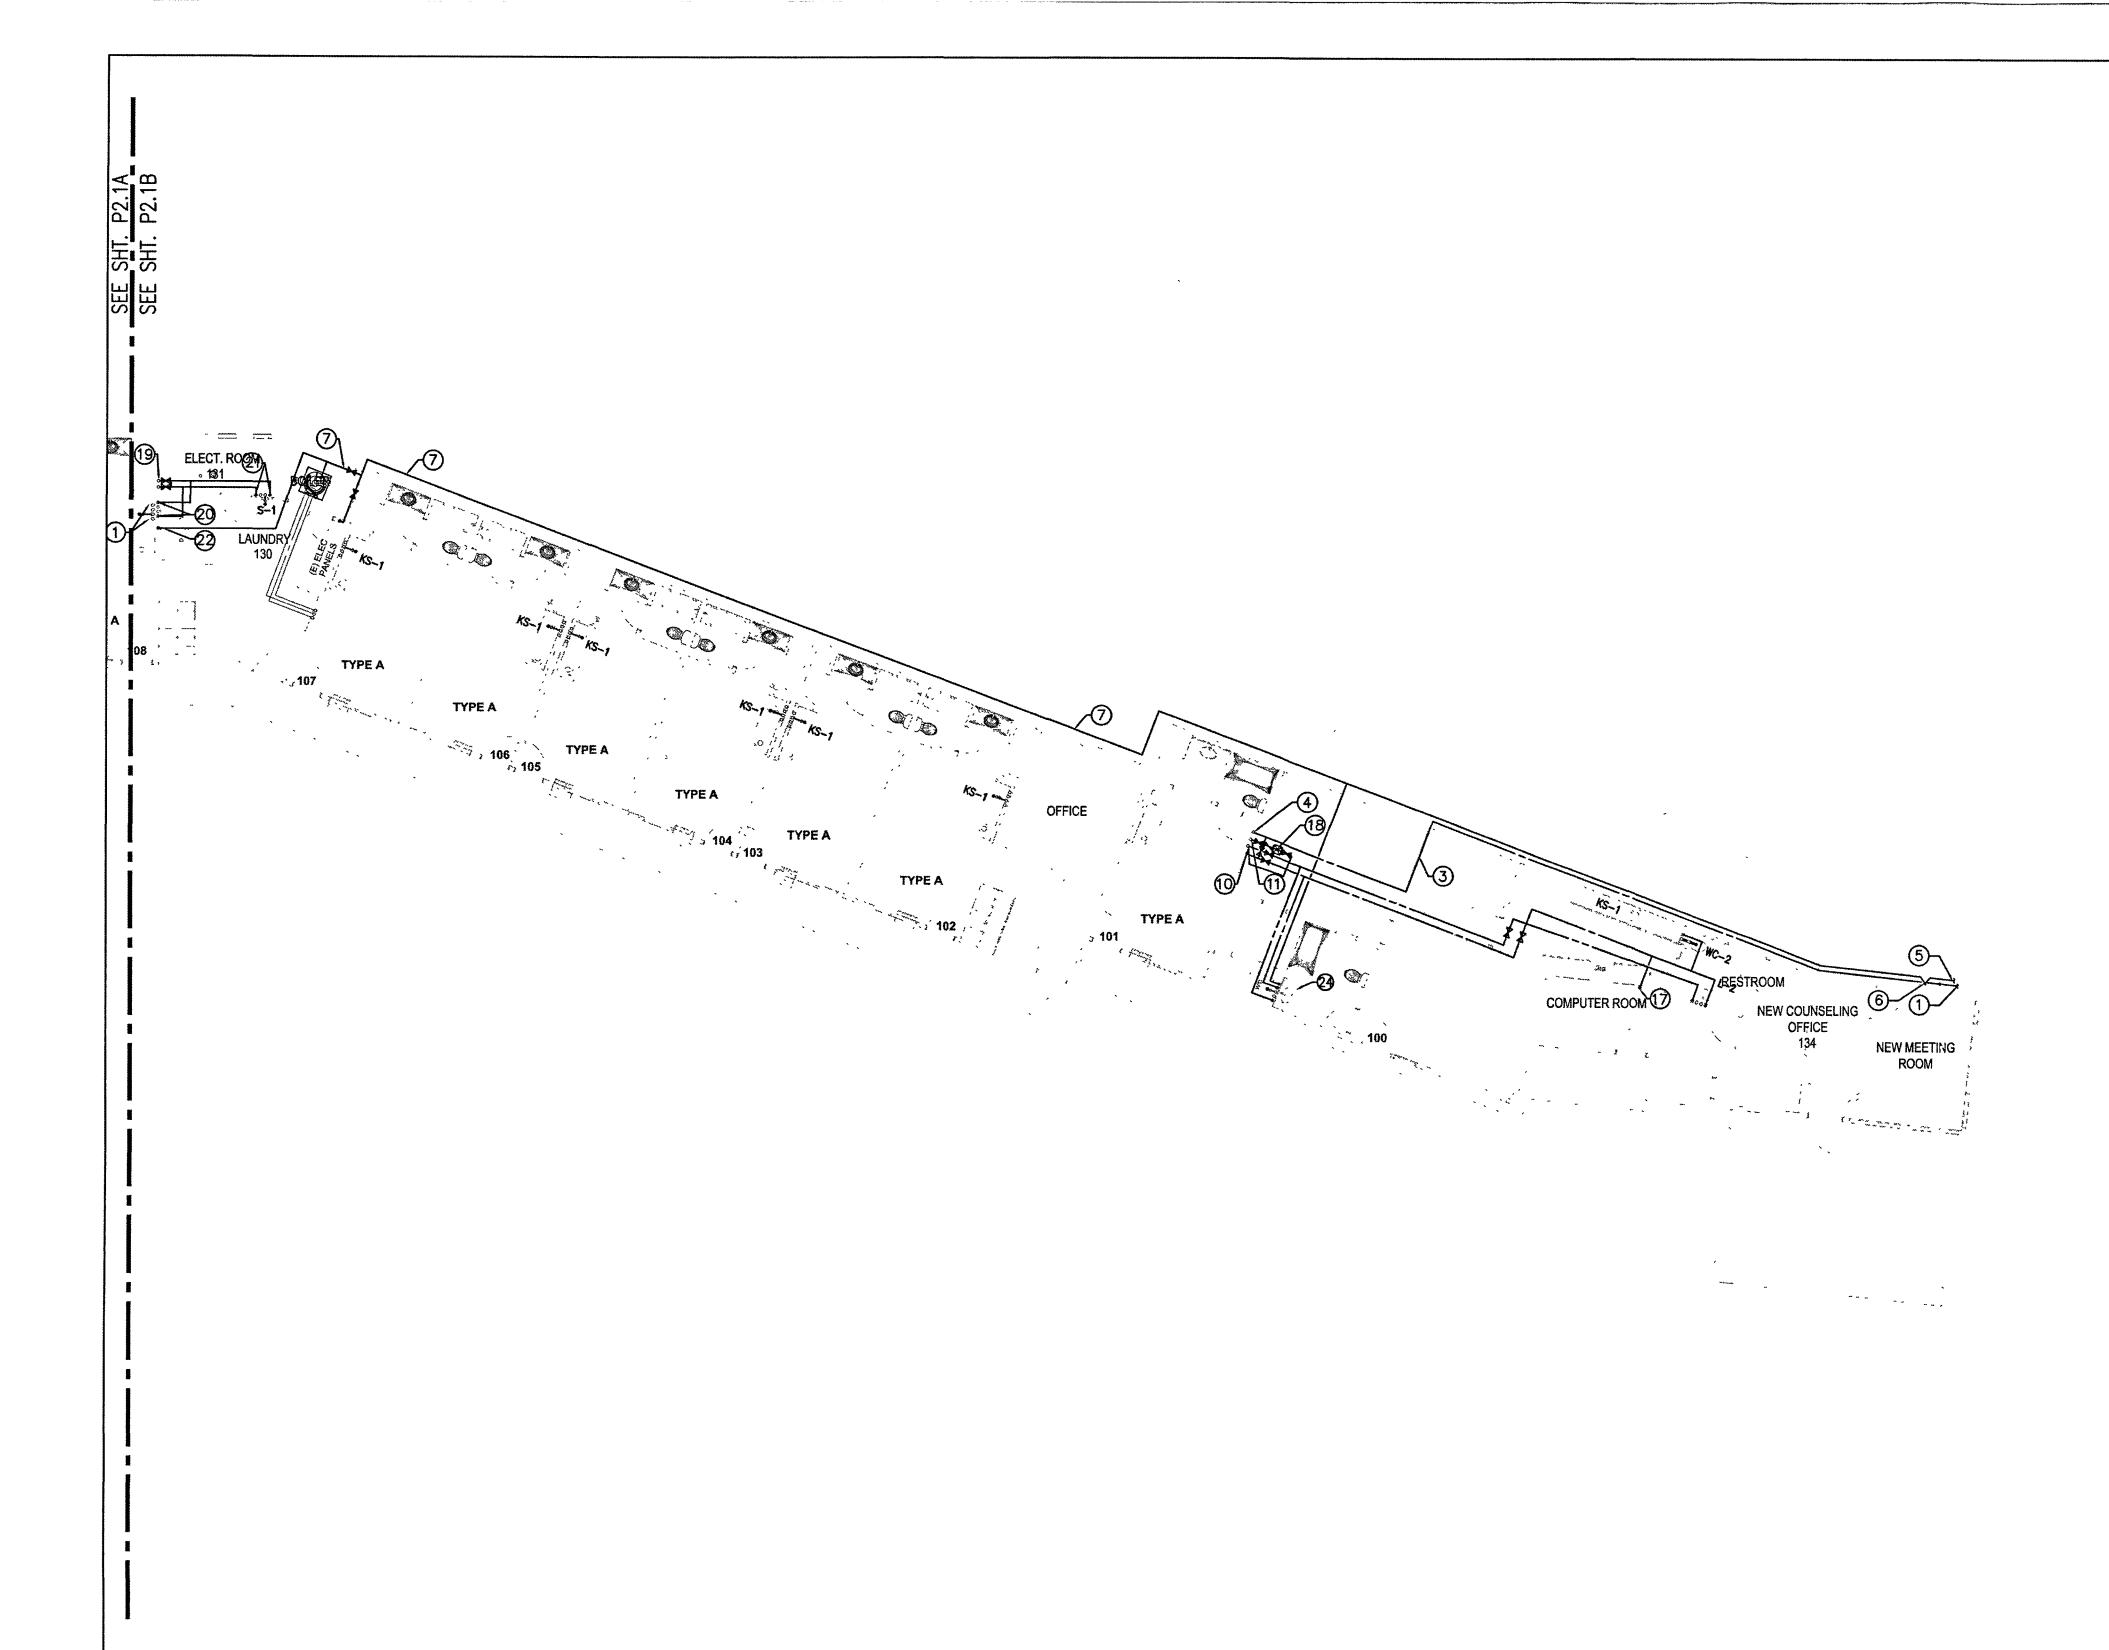
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PLUMBING
ENLARGED
PARTIAL FIRST
FLOOR WATER &
GAS PLAN

SHEET NO:

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PLUMBING ENLARGED PARTIAL FIRST FLOOR WATER AND GAS PLAN

TO SHOWER STALL. REFER TO ARCHITECT & ADA REQUIREMENTS OF EXACT LOCATION OF SHOWER HEAD, VALVES & CONTROLS

PLUMBING REFERENCE NOTES

- 1 2-1/2" COLD WATER & CONNECT TO MAIN. VERIFY ON SITE OF EXACT (4) 1" COLD WATER & 1" HOT WATER SUPPLY @ CEILING & DOWN LOCATION OF MAIN WATER LINE. UPSIZE MAIN WATER LINE IF REQUIRED.
- 2 2-1/2" COLD WATER © CEILING LEVEL.
- 3 2-1/2" COLD WATER © CEILING.
- ④ 2-1/2* COLD WATER CEILING & UP TO SECOND FLOOR CEILING OR ATTIC.
- 5 1-1/2" GAS & CONNECT TO MAIN. VERIFY ON SITE OF EXACT LOCATION OF MAIN GAS LINE. UP SIZE MAIN GAS LINE IF REQUIRED.
- ⑥ 1-1/2" GAS & UP TO CEILING LEVEL.

DOWN TO LAVATORY.

- 8 1-1/4" GAS CEILING & UP TO SECOND FLOOR.
- 9 1" COLD WATER & 1" HOT WATER SUPPLY FROM ABOVE & DOWN TO
- KITCHEN SINK. SEE HOT & COLD WATER RISER DIAGRAMS. (TYPICAL)
- 1-1/2* HOT WATER SUPPLY @ CEILING & FROM ABOVE.
- 1" HOT WATER RETURN @ CEILING & FROM SECOND FLOOR. 1" COLD WATER @ CEILING & DOWN TO WATER CLOSET.
- 3/4" COLD WATER & 3/4" HOT WATER SUPPLY @ CEILING &

1" COLD WATER & 1" HOT WATER SUPPLY @ CEILING & DOWN KITCHEN SINK. 3/4" HOT WATER TO DISHWASHER.

SCALE: 1/8"=1'-0"

- 1" COLD WATER & 1" HOT WATER SUPPLY @ CEILING & DOWN TO CLOTHES WASHER.
- (3) CIRCUIT SOLVER WITH CHECK VALVE AND SHUT-OFF VALVE.
- 1-1/2" COLD WATER & 1-1/2" HOT WATER SUPPLY FROM SECOND FLOOR.
- 1" COLD WATER & 1" HOT WATER SUPPLY @ CEILING & DOWN TO CLOTHES WASHER.
- 2 1" COLD WATER & 1" HOT WATER SUPPLY @ CEILING & DOWN
- 2 3/4" GAS @ CEILING & DOWN CONNECT TO CLOTHES DRYER. (TYPICAL)
- (3) 1" GAS @ CEILING & DOWN CONNECT TO GAS RANGE. (E) LAVATORY TO BE RELOCATE.

GENERAL NOTES

- (1) WASTE PIPING BELOW GROUND TO BE CAST IRON.
- WASTE & VENT PIPING ABOVE GROUND TO BE CAST IRON.
- (3) USE SOUND ISOLATION BRACKETS FOR WATER PIPING.
- PROVIDE INSULATION FOR TRAPS ON ALL ADA ACCESS FIXTURES.
- 5 PROVIDE ANGLE STOPS FOR EACH INDIVIDUAL FIXTURE.
- (6) SEE ARCHITECTURAL DRAWINGS FOR EXACT DIMENSIONS.
- SEE WASTE & VENT, GAS, HOT & COLD WATER PIPING RISER DIAGRAMS.
- (8) SEE PLUMBING SITE PLAN AND CIVIL DRAWINGS.
- 9 CONNECT VENTS IN ROOF ATTIC SPACE & VERIFY EXACT LOCATIONS OF ROOF PENETRATIONS WITH ARCHITECT.
- 10> LOWER ROUGH-IN HEIGHTS FOR ALL ADA & ADAPTABLE KITCHENS.
- (1) VERIFY ON SITE EXACT LOCATION OF MANHOLE.

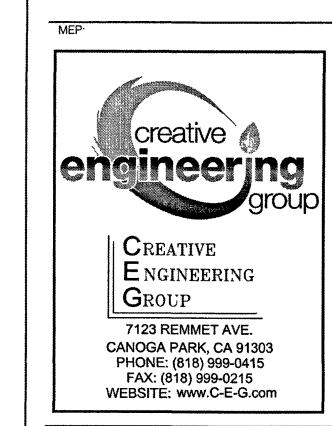
- PLUMBING CONTRACTOR SHALL CARRY ALLOWANCE TO PROVIDE A COMPLETE PLUMBING SYSTEM FOR ALL AREAS INCLUDING PLUMBING FIXTURE ROUGH—IN AND ALL UTILITY
- ALL REQUIRED CLEANOUTS SHALL BE INSTALLED AS PER

SECTION 707.0 & 719.0 OF THE CALIFORNIA PLUMBING CODE, 2019.

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PLUMBING ENLARGED PARTIAL SECOND FLOOR WASTE AND VENT PLAN

SCALE: 1/8"=1'-0"

PLUMBING REFERENCE NOTES

(N) 2" WASTE DOWN & 1-1/2" VENT UP THRU ROOF.
(TYPICAL FOR KITCHEN SINK)

GENERAL NOTES PLUMBING CONTRACTOR SHALL CARRY ALLOWANCE TO PROVIDE A COMPLETE PLUMBING SYSTEM FOR ALL AREAS INCLUDING PLUMBING FIXTURE ROUGH—IN AND ALL UTILITY (1) WASTE PIPING BELOW GROUND TO BE CAST IRON. (2) WASTE & VENT PIPING ABOVE GROUND TO BE CAST IRON. (3) USE SOUND ISOLATION BRACKETS FOR WATER PIPING. ALL REQUIRED CLEANOUTS SHALL BE INSTALLED AS PER SECTION 707.0 & 719.0 OF THE CALIFORNIA PLUMBING 4> PROVIDE INSULATION FOR TRAPS ON ALL ADA ACCESS FIXTURES. CODE, 2019. (5) PROVIDE ANGLE STOPS FOR EACH INDIVIDUAL FIXTURE. PLUMBING CONTRACTOR SHALL PROVIDE ROUGH—INS, EXTEND ALL PIPING (WASTE, VENT, COLD WATER, HOT WATER, ETC.) TO ALL FIXTURES AS INDICATED ON THE ARCHITECTURAL DRAWINGS. SEE ARCHITECTURAL DRAWINGS FOR EXACT DIMENSIONS. SEE WASTE & VENT, GAS, HOT & COLD WATER PIPING RISER DIAGRAMS. SEE PLUMBING SITE PLAN AND CIVIL DRAWINGS. OF ROOF PENETRATIONS WITH ARCHITECT. (10) LOWER ROUGH-IN HEIGHTS FOR ALL ADA & ADAPTABLE KITCHENS. VERIFY ON SITE EXACT LOCATION OF MANHOLE.

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PLUMBING
ENLARGED
PARTIAL SECOND
FLOOR WASTE &
VENT PLAN

SHEET NO

P2.2.1A

A: 5,130.85 sq ft PLUMBING ENLARGED PARTIAL SECOND FLOOR WASTE AND VENT PLAN

PLUMBING REFERENCE NOTES

- (N) 2" WASTE DOWN & 1-1/2" VENT UP THRU ROOF. (TYPICAL FOR KITCHEN SINK)
- ② (N) 1-1/2" VENT UP THRU ROOF.
- (N) 2" VENT UP THRU ROOF.

SCALE: 1/8"=1'-0"

GENERAL NOTES

- WASTE PIPING BELOW GROUND TO BE CAST IRON.
- WASTE & VENT PIPING ABOVE GROUND TO BE CAST IRON.

 3 USE SOUND ISOLATION BRACKETS FOR WATER PIPING.
- PROVIDE INSULATION FOR TRAPS ON ALL ADA ACCESS FIXTURES.
- 5 PROVIDE ANGLE STOPS FOR EACH INDIVIDUAL FIXTURE.
 6 SEE ARCHITECTURAL DRAWINGS FOR EXACT DIMENSIONS.
- SEE WASTE & VENT, GAS, HOT & COLD WATER PIPING RISER DIAGRAMS.
- SEE PLUMBING SITE PLAN AND CIVIL DRAWINGS.
- © CONNECT VENTS IN ROOF ATTIC SPACE & VERIFY EXACT LOCATIONS OF ROOF PENETRATIONS WITH ARCHITECT.
- LOWER ROUGH-IN HEIGHTS FOR ALL ADA & ADAPTABLE KITCHENS.

 VERIFY ON SITE EXACT LOCATION OF MANHOLE.

- PLUMBING CONTRACTOR SHALL CARRY ALLOWANCE TO PROVIDE A COMPLETE PLUMBING SYSTEM FOR ALL AREAS INCLUDING PLUMBING FIXTURE ROUGH—IN AND ALL UTILITY PIPES.
- ALL REQUIRED CLEANOUTS SHALL BE INSTALLED AS PER SECTION 707.0 & 719.0 OF THE CALIFORNIA PLUMBING CODE, 2019.
- PLUMBING CONTRACTOR SHALL PROVIDE ROUGH-INS, EXTEND ALL PIPING (WASTE, VENT, COLD WATER, HOT WATER, ETC.) TO ALL FIXTURES AS INDICATED ON THE ARCHITECTURAL DRAWINGS.

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Building 2

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SCALE: 1/8"=1'-0"

PLUMBING ENLARGED PARTIAL SECOND FLOOR WATER AND GAS PLAN

PLUMBING REFERENCE NOTES

- 1" COLD WATER & 1" HOT WATER SUPPLY & DOWN TO KITCHEN SINK. SEE HOT & COLD WATER RISER DIAGRAMS. (TYPICAL)
- 2 1" COLD WATER & 1" HOT WATER SUPPLY & DOWN TO KITCHEN SINK @ FIRST FLOOR. SEE HOT & COLD WATER RISER DIAGRAMS. (TYPICAL)
- 3 CIRCUIT SOLVER WITH CHECK VALVE AND SHUT-OFF VALVE.

GENERAL NOTES

- waste piping below ground to be cast iron.
- 2 WASTE & VENT PIPING ABOVE GROUND TO BE CAST IRON.

 3 USE SOUND ISOLATION BRACKETS FOR WATER PIPING.
- PROVIDE INSULATION FOR TRAPS ON ALL ADA ACCESS FIXTURES.
- 5> PROVIDE ANGLE STOPS FOR EACH INDIVIDUAL FIXTURE.
- 6> SEE ARCHITECTURAL DRAWINGS FOR EXACT DIMENSIONS,
- SEE WASTE & VENT, GAS, HOT & COLD WATER PIPING RISER DIAGRAMS.
- (8) SEE PLUMBING SITE PLAN AND CIVIL DRAWINGS.
- 9 CONNECT VENTS IN ROOF ATTIC SPACE & VERIFY EXACT LOCATIONS OF ROOF PENETRATIONS WITH ARCHITECT.
- 10 LOWER ROUGH-IN HEIGHTS FOR ALL ADA & ADAPTABLE KITCHENS.
- VERIFY ON SITE EXACT LOCATION OF MANHOLE.

- PLUMBING CONTRACTOR SHALL CARRY ALLOWANCE TO PROVIDE A COMPLETE PLUMBING SYSTEM FOR ALL AREAS INCLUDING PLUMBING FIXTURE ROUGH—IN AND ALL UTILITY
- ALL REQUIRED CLEANOUTS SHALL BE INSTALLED AS PER SECTION 707.0 & 719.0 OF THE CALIFORNIA PLUMBING CODE, 2019.
- PLUMBING CONTRACTOR SHALL PROVIDE ROUGH-INS, EXTEND ALL PIPING (WASTE, VENT, COLD WATER, HOT WATER, ETC.) TO ALL FIXTURES AS INDICATED ON THE ARCHITECTURAL DRAWINGS.

WARNING: THIS DRAWING MAY HAVE BEEN REDUCED DURING PRINTING. VERIFY SCALE BEFORE MEASURING ANY PART OF THE DRAWING.

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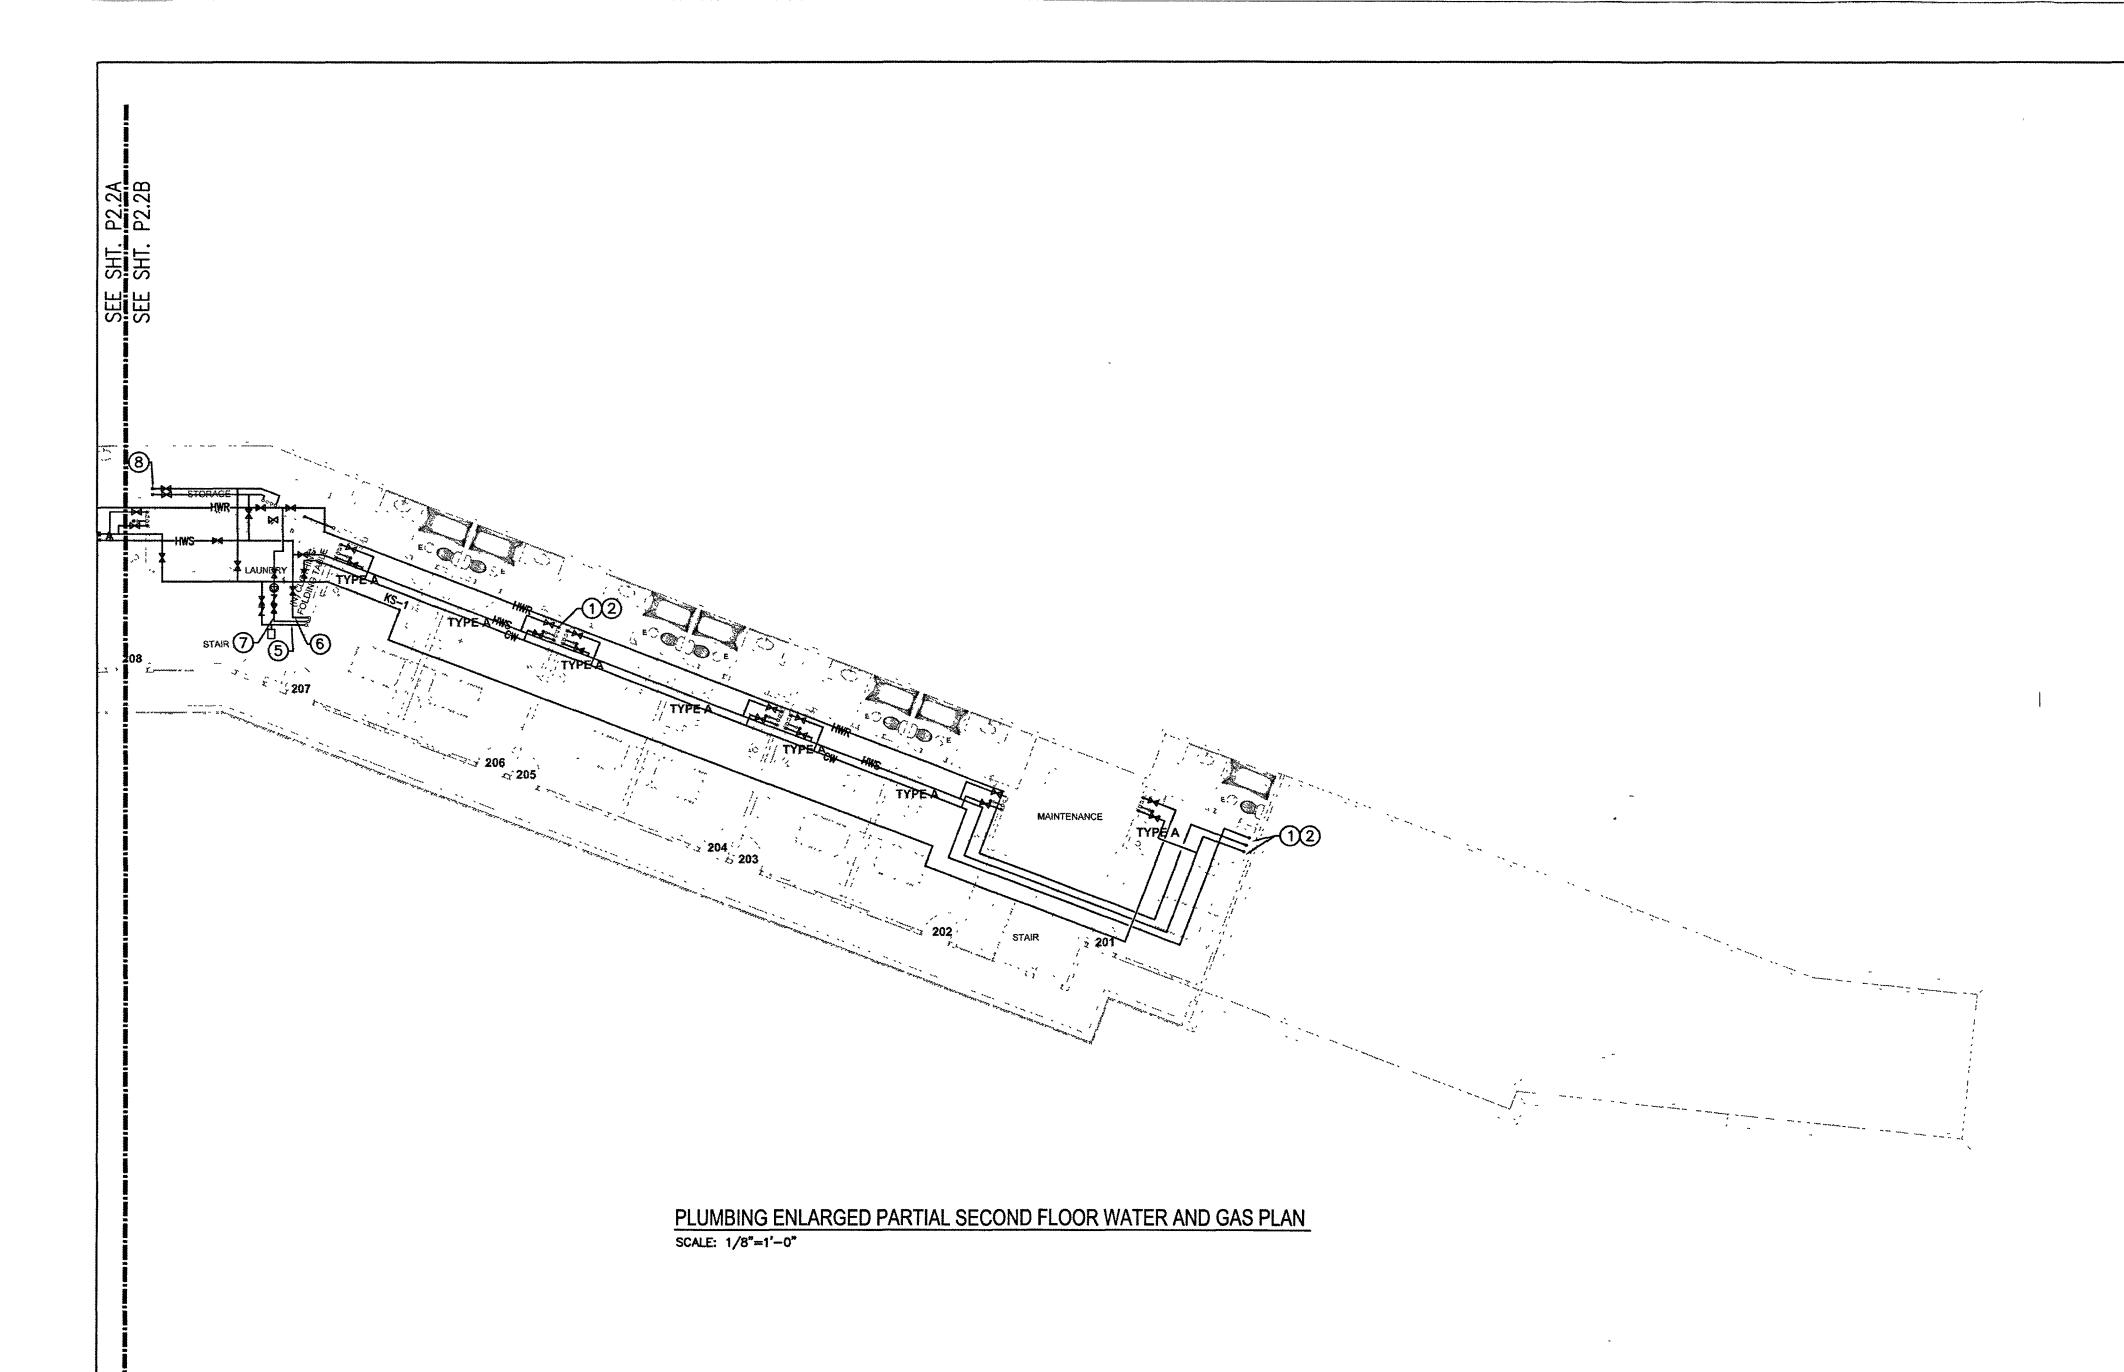
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AN	D GAS	PLAN

P2.2A

SHEET NO:



PLUMBING REFERENCE NOTES

- 1" COLD WATER & 1" HOT WATER SUPPLY & DOWN TO KITCHEN SINK. SEE HOT & COLD WATER RISER DIAGRAMS. (TYPICAL)
- 2) 1" COLD WATER & 1" HOT WATER SUPPLY & DOWN TO KITCHEN SINK @ FIRST FLOOR. SEE HOT & COLD WATER RISER DIAGRAMS. (TYPICAL)
- 3 1-1/4" GAS FROM BELOW & UP TO CEILING.
- 4 1-1/4" GAS & DOWN TO WATER HEATER.
- ⑤ 2-1/2* COLD WATER CEILING & DOWN TO WATER HEATER.
- ⑥ 2-1/2" HOT WATER SUPPLY FROM WATER HEATER & UP TO CEILING.
- 1-1/4" HOT WATER RETURN @ CEILING & DOWN TO WATER HEATER. 8 1-1/2" COLD WATER & 1-1/2" HOT WATER SUPPLY & DOWN TO FIRST FLOOR LAUNDRY ROOM.

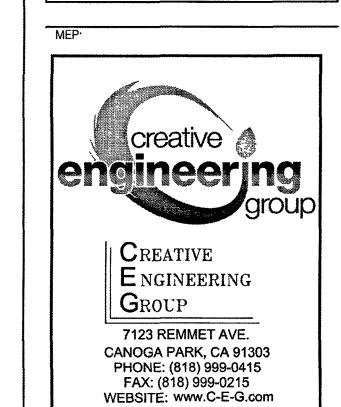
GENERAL NOTES

- (1) WASTE PIPING BELOW GROUND TO BE CAST IRON.
- WASTE & VENT PIPING ABOVE GROUND TO BE CAST IRON.
- USE SOUND ISOLATION BRACKETS FOR WATER PIPING.
- PROVIDE INSULATION FOR TRAPS ON ALL ADA ACCESS FIXTURES.
- 5 PROVIDE ANGLE STOPS FOR EACH INDIVIDUAL FIXTURE.
- 6 SEE ARCHITECTURAL DRAWINGS FOR EXACT DIMENSIONS. SEE WASTE & VENT, GAS, HOT & COLD WATER PIPING RISER DIAGRAMS.
- 8 SEE PLUMBING SITE PLAN AND CIVIL DRAWINGS.
- © CONNECT VENTS IN ROOF ATTIC SPACE & VERIFY EXACT LOCATIONS OF ROOF PENETRATIONS WITH ARCHITECT.
- LOWER ROUGH-IN HEIGHTS FOR ALL ADA & ADAPTABLE KITCHENS. VERIFY ON SITE EXACT LOCATION OF MANHOLE.

- PLUMBING CONTRACTOR SHALL CARRY ALLOWANCE TO PROVIDE A COMPLETE PLUMBING SYSTEM FOR ALL AREAS INCLUDING PLUMBING FIXTURE ROUGH-IN AND ALL UTILITY
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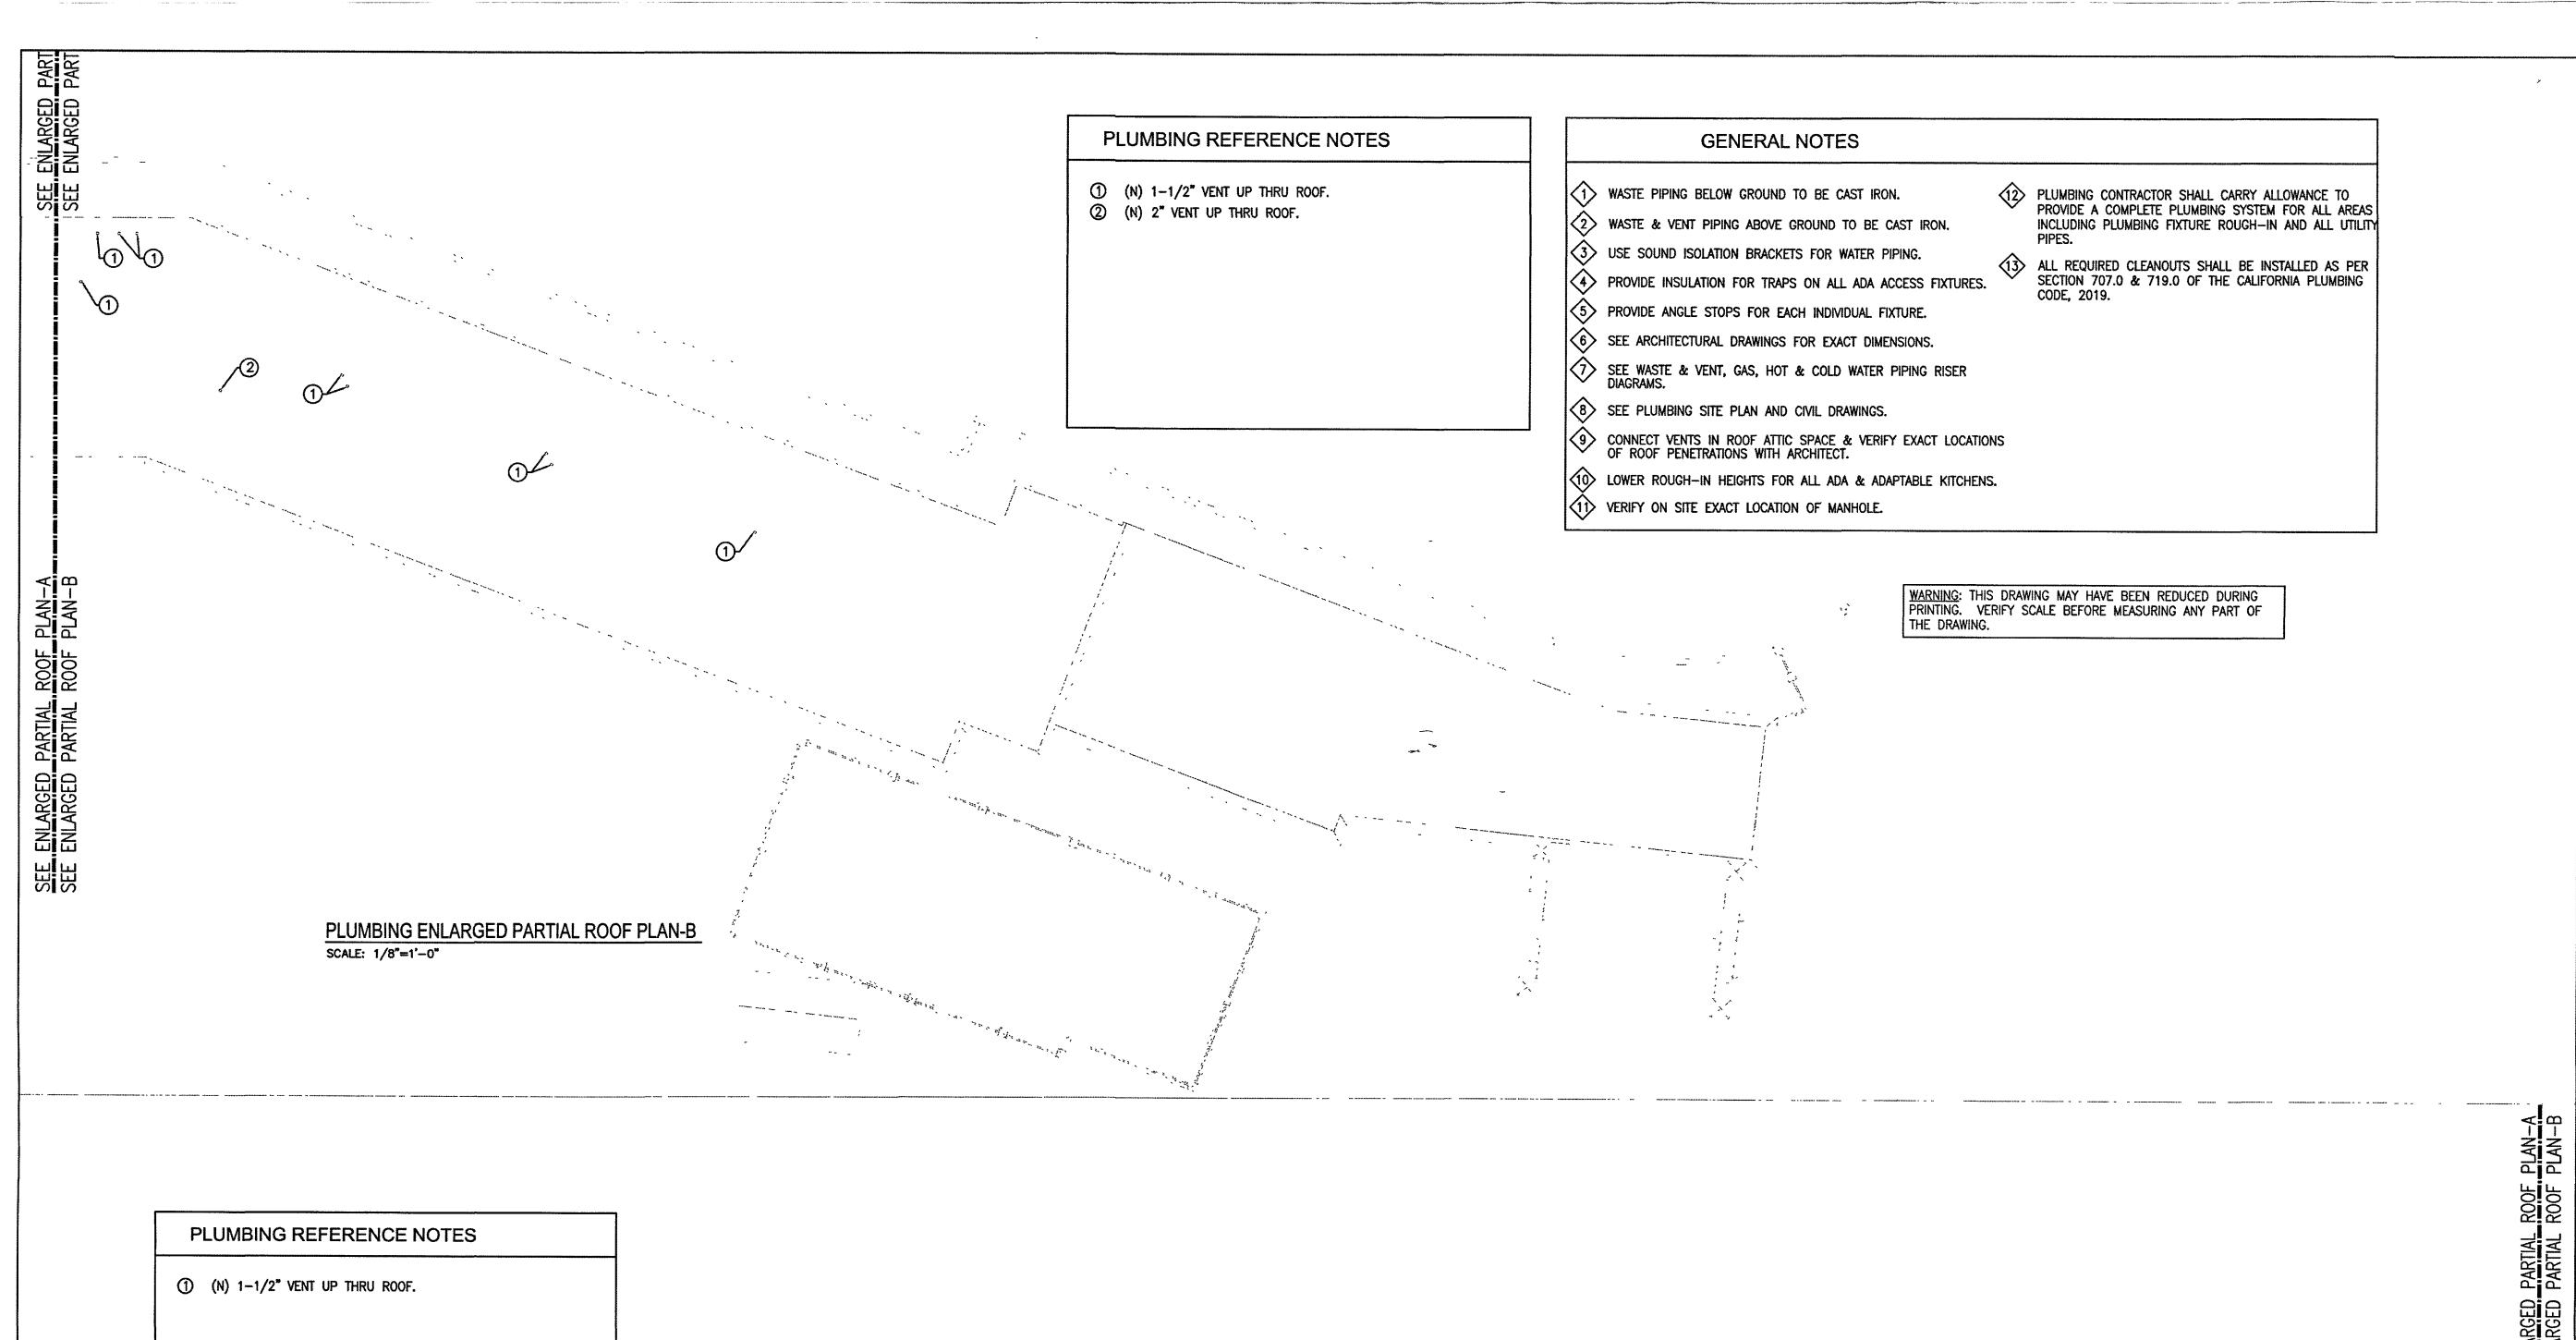
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SHEET NO:

AND GAS PLAN



GENERAL NOTES

- (1) WASTE PIPING BELOW GROUND TO BE CAST IRON.
- 2 WASTE & VENT PIPING ABOVE GROUND TO BE CAST IRON.
- 3 USE SOUND ISOLATION BRACKETS FOR WATER PIPING.
- PROVIDE INSULATION FOR TRAPS ON ALL ADA ACCESS FIXTURES.
- 5 PROVIDE ANGLE STOPS FOR EACH INDIVIDUAL FIXTURE.
- 6 SEE ARCHITECTURAL DRAWINGS FOR EXACT DIMENSIONS.
- SEE WASTE & VENT, GAS, HOT & COLD WATER PIPING RISER DIAGRAMS.
- 8 SEE PLUMBING SITE PLAN AND CIVIL DRAWINGS.
- © CONNECT VENTS IN ROOF ATTIC SPACE & VERIFY EXACT LOCATIONS OF ROOF PENETRATIONS WITH ARCHITECT.
- 10 LOWER ROUGH-IN HEIGHTS FOR ALL ADA & ADAPTABLE KITCHENS.
- VERIFY ON SITE EXACT LOCATION OF MANHOLE.
- PLUMBING CONTRACTOR SHALL CARRY ALLOWANCE TO PROVIDE A COMPLETE PLUMBING SYSTEM FOR ALL AREAS INCLUDING PLUMBING FIXTURE ROUGH—IN AND ALL UTILITY PIPES
- ALL REQUIRED CLEANOUTS SHALL BE INSTALLED AS PER SECTION 707.0 & 719.0 OF THE CALIFORNIA PLUMBING CODE, 2019.

PLUMBING ENLARGED PARTIAL ROOF PLAN-A
SCALE: 1/8*=1'-0"

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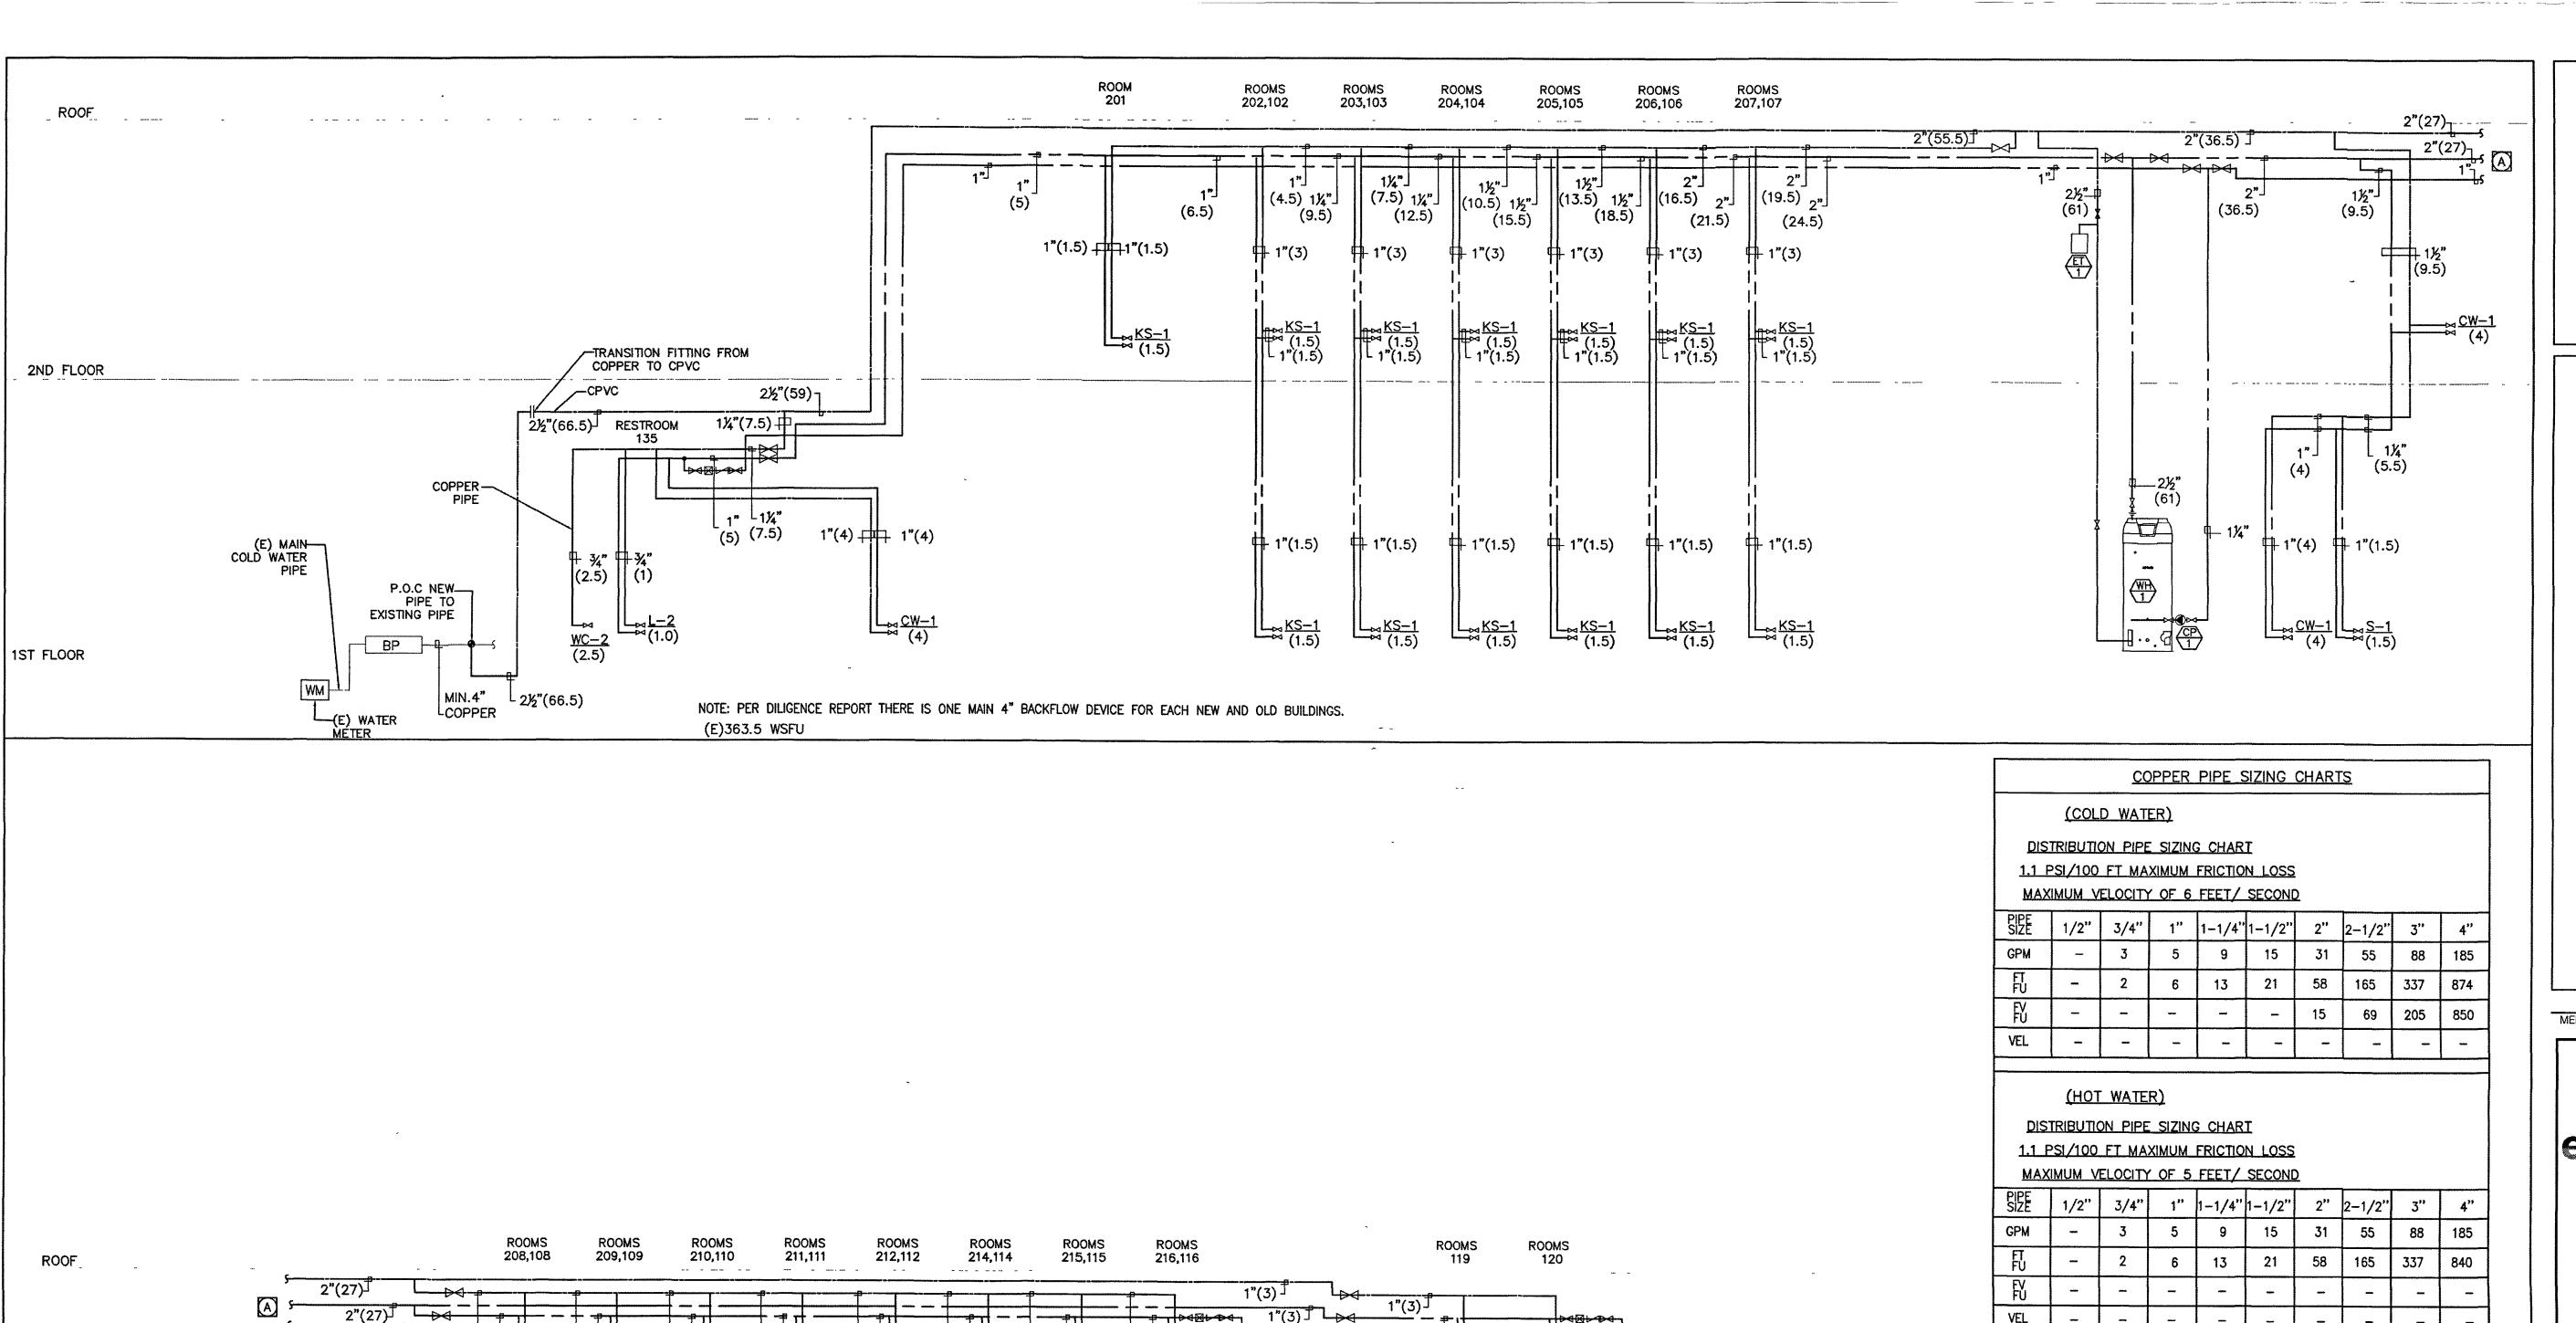
PLUMBING ROOF PLAN

SHEET NO.

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22.3

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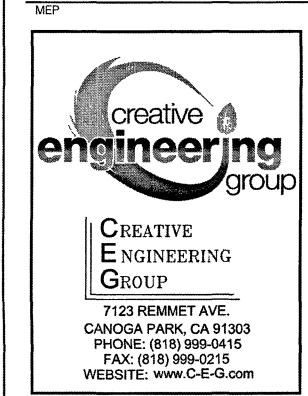
		<u>C</u> I	PVC PIPE	SIZING	CHARTS				
	(COLD WATER)								
DIS"	RIBUTI	ON PIP	E SIZIN	NG CHA	ART				
1.1 F	SI/100	FT M	AXIMUN	FRICT	ION LO	<u>)SS</u>			
MAX	MAXIMUM VELOCITY OF 6 FEET/ SECOND								
	"Cł	FLOWGUARD GOLD SDR11 "CORZAN" CPVC SCH. 80 "CHARLOTTE" L.A. TEST LAB # RR-5697 "HARVEL" L.A. TEST LAB # RR-569					80 RR-5695		
PIPE SIZE	3/4"	1"	1-1/4"	1-1/2"	2"	2-1/2	3"	4"	
GPM	2	4	7	11	23	50	90	180	
FT FU	1	4	8	15	36	127	326	809	
ΕV					6	55	224	800	

			<u> </u>	<u> </u>			<u> </u>		
	<u>CP</u>	VC PIF	E SIZI	NG CH	ARTS				
	<u>(</u> L	OT WA	TER)				··········		
DIST	RIBUTIO	N PIP	E SIZIN	IG CHA	RT				
<u>1.0 P</u>	SI/100	FT MA	AXIMUM	FRICT	ION LO	<u>SS</u>			
MAXI	MUM V	ELOCIT	Y OF 6	FEET,	/ SECC	<u>DND</u>			
	*CI	FLOWGUA HARLOTTE	RD GOLD L.A. TES	SDR11 T LAB # 1	RR-5697	"CORZA "HARVEL"	n" cpvc L.a. tes	SCH. 80 T LAB # F	RR-5695
PIPE SIZE	3/4"	1"	1-1/4"	1-1/2"	2"	2-1/2'	3"	4"	
GPM	2	4	7	11	23	50	90	180	
FT FU	1	4	8	15	36	127	326	809	٠
FV FU	*****		***		***	-		_	
VEL					_	_	_	_	

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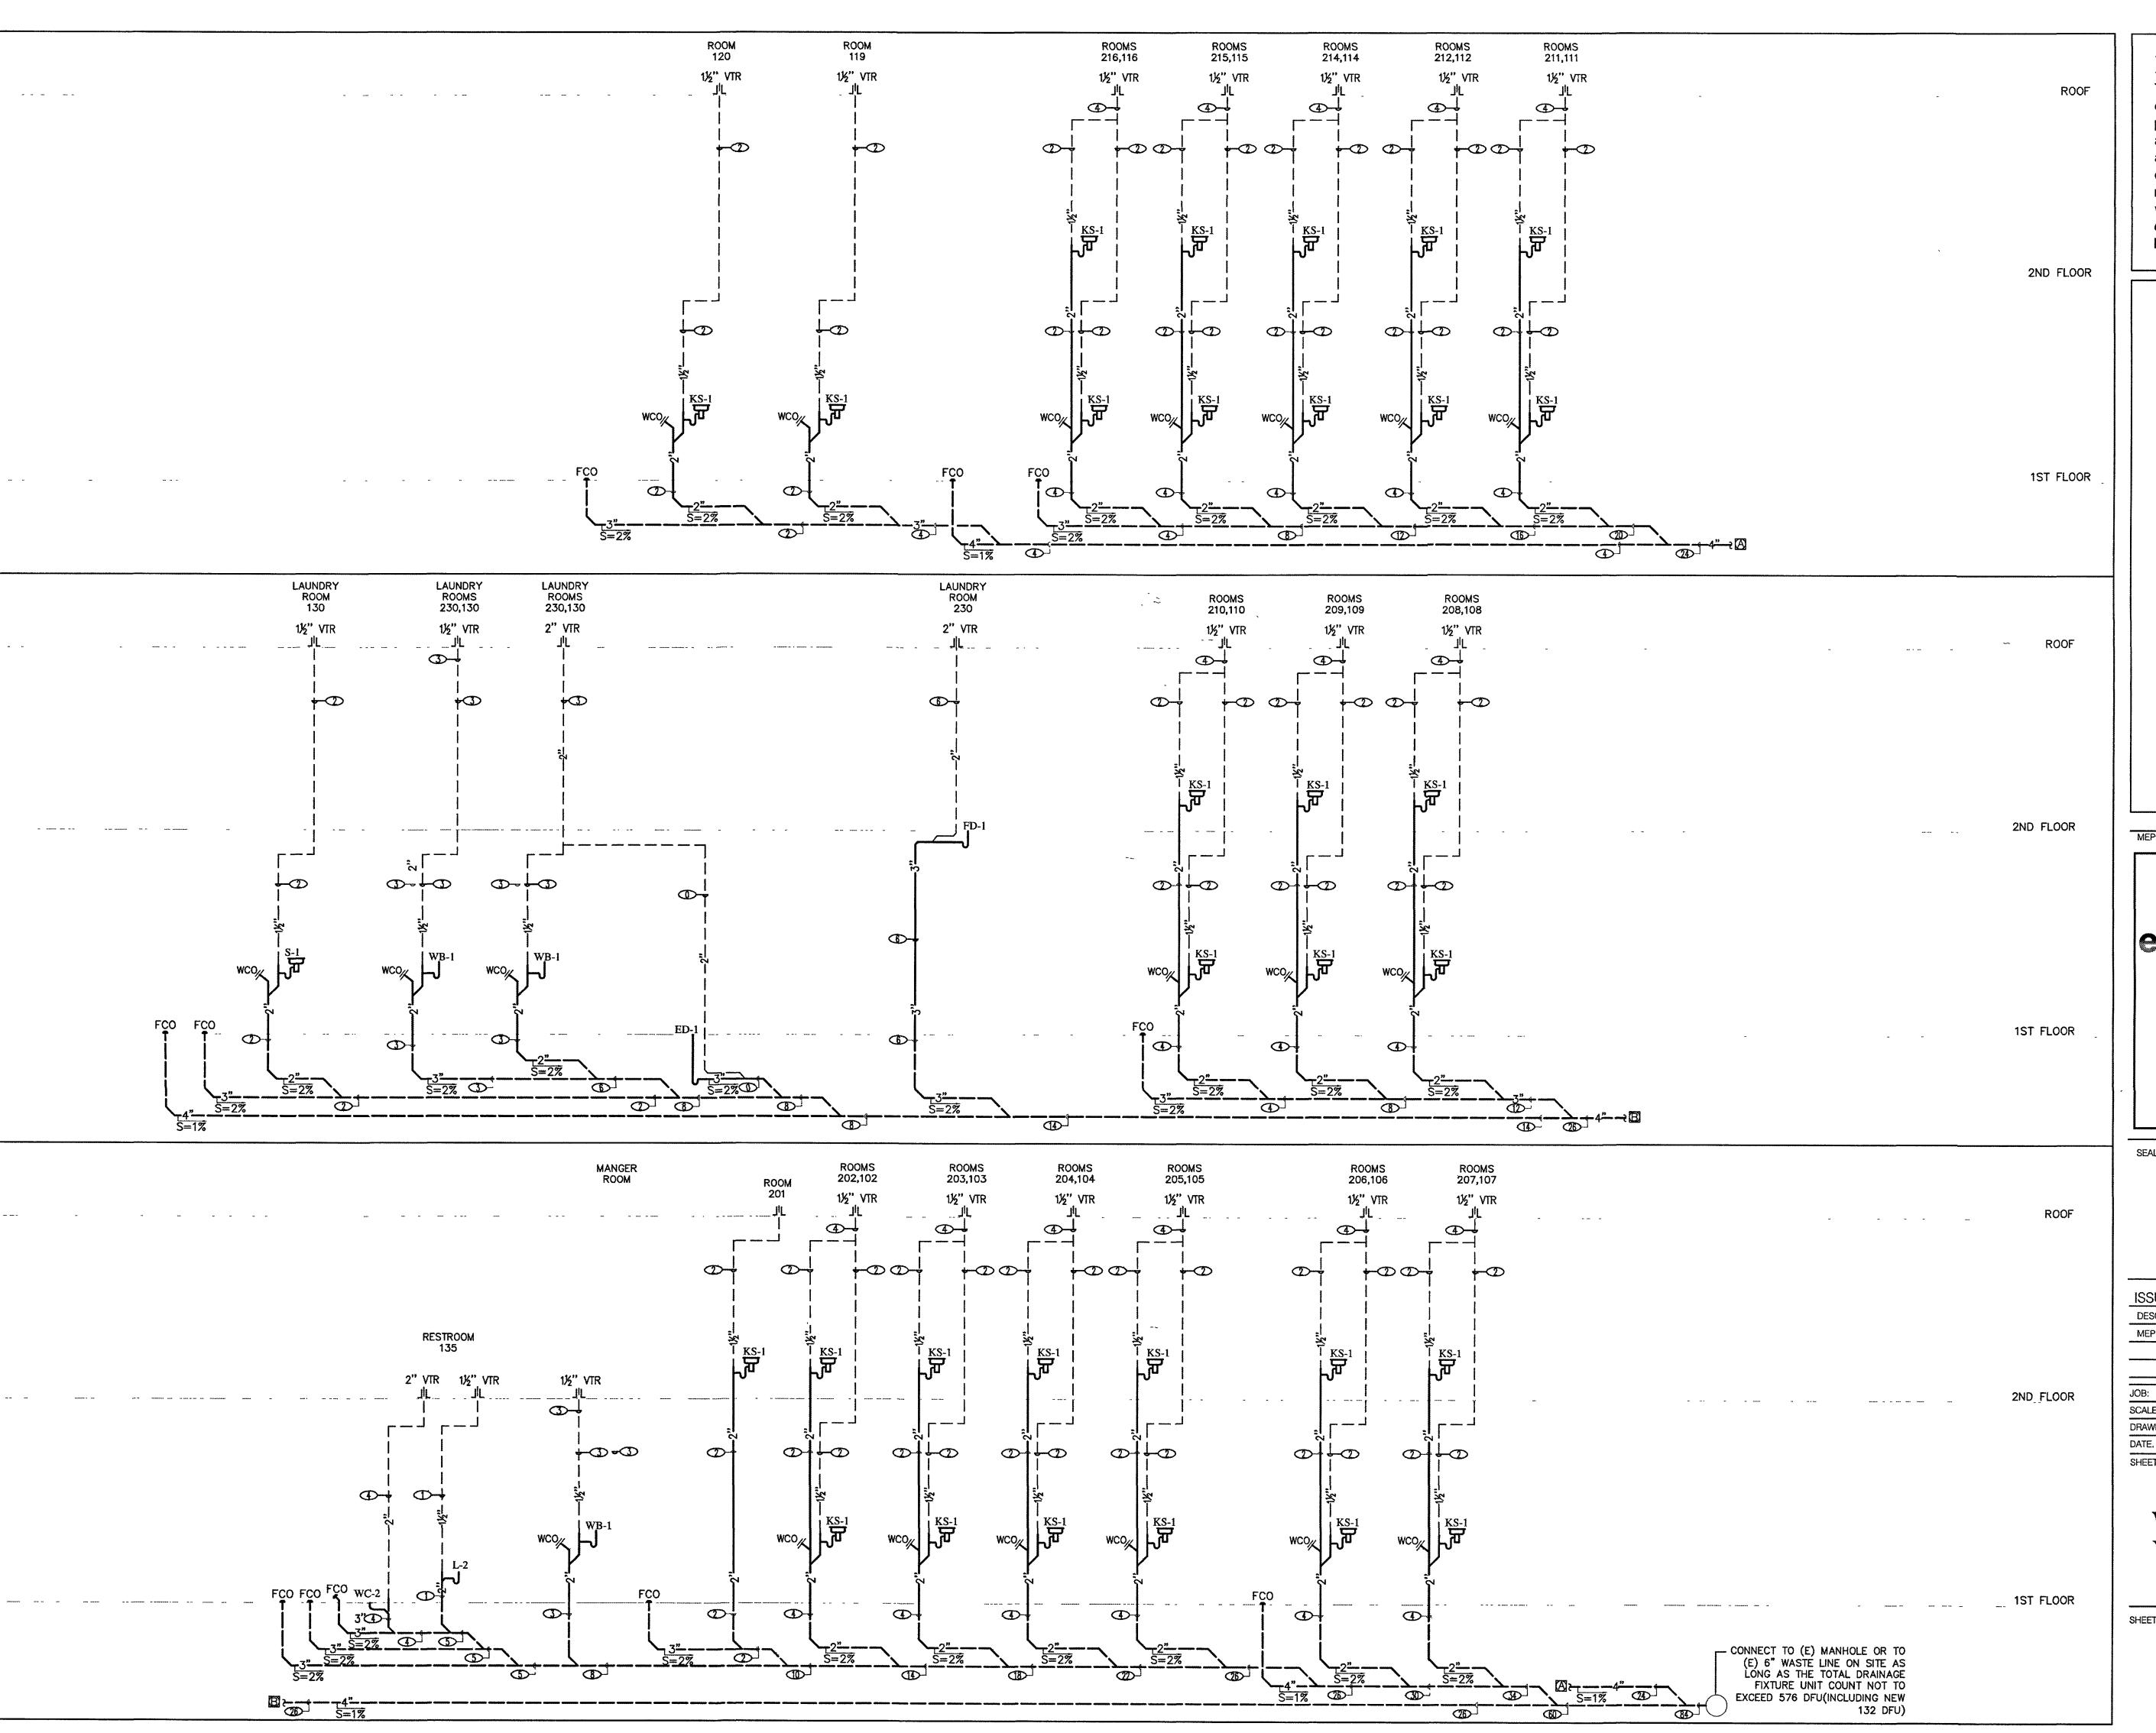


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PLUMBING HOT AND COLD WATER RISER DIAGRAMS

SHEET NO:

P3.1



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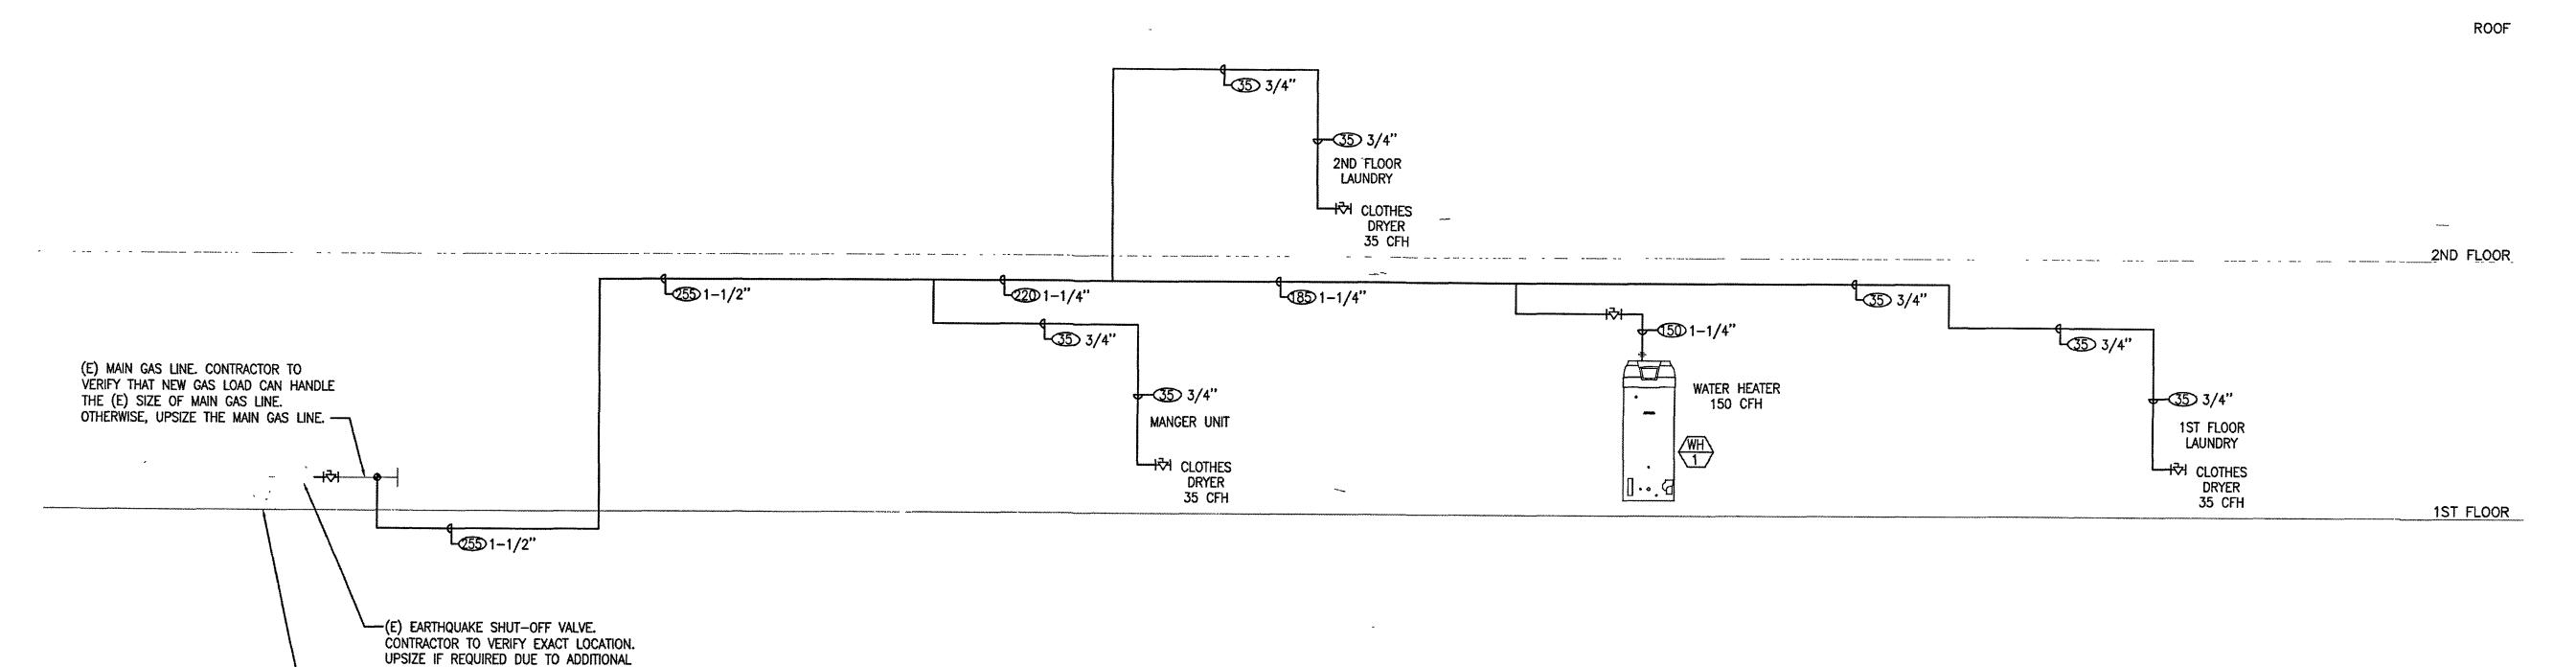


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PLUMBING WASTE AND **VENT RISER DIAGRAMS**

SHEET NO

P4.1



NEW GAS LOAD.

(E)GAS METER AND REGULATOR BY
GAS COMPANY, ANY CHANGE IN GAS
LOAD SHALL BE CONFIRMED WITH
GAS COMPANY.

VERIFY EXACT LOCATION OF (E) GAS METER

NEW GAS LOAD (TOTAL GAS LOAD)							
<u>FIXTURE</u>	QTY		ВТ	UH			CFH
WATER HEATER	1	150,000	Х	1	****	150,000	150
CLOTHES DRYER	3	35,000	Χ	3		105,000	105
TOTAL GAS LOAD						255,000	255

DETAIL LEGEND

CUBIC FEET PER HOUR
(CFH)

- TOTAL SYSTEM NEW DEMAND FOR HOUSE METER 320 CFH.
- LOW PRESSURE GAS:

 DEVELOPED LENGTH OF 300 FT. FROM REGULATOR
 TO FURTHEST OUTLET
- USE TABLE 1215.2(1) CPC FOR LOW PRESSURE GAS.

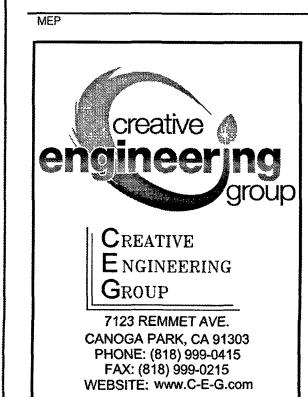
NOTES:

- 1. DEVELOPED LENGTH OF 300 FT. FROM REGULATOR TO FURTHEST OUTLET.
- 2. PROVIDE EARTHQUAKE SHUT-OFF VALVE.

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PLUMBING GAS RISER DIAGRAMS

SHEET NO.

P5.1