SERVICE - WATER HEATING NOTES

. INSULATION OF DOMESTIC HOT WATER PIPING SHALL BE IN ACCORDANCE WITH 2019 CPC SECTION 609.11, AND SECTION 120.3, TABLE 120.3-A OF THE 2019 BUILDING ENERGY EFFICIENCY STANDARDS WHICHEVER IS

- ALL HOT WATER PIPE TO BE INSULATED WITH SNAP-ON TYPE FIBERGLAS INSULATION WITH STAPLED CANVAS JACKETS.
- THE THICKNESS OF INSULATION LISTED ABOVE IS BASED ON MATERIALS. HAVING A THERMAL RESISTANCE IN THE RANGE OF R-7.7 TO R-12.5 PER INCH. ADJUSTMENTS ARE REQUIRED FOR INSULATION MATERIALS OUTSIDE

ACOUSTICAL NOTES

- 1. ALL OF THE PLUMBING SYSTEM MUST BE ISOLATED FROM THE BUILDING - FOR 1/2" TO 2" DIAMETER PIPES, USE HOLDRITE ACOUSTIPLUMB ISOLATOR. - FOR PIPING GREATER THAN 2" DIAMETER, FELT WRAP ALL PIPING WHERE IT IS IN DIRECT CONTACT WITH STRUCTURE. NO PIPING SHALL TOUCH
- STRUCTURE WITHOUT FELT WRAP. 2. THE ELBOWS BELOW TOILET AND TUB WASTE OUTLETS SHALL BE ISOLATED FROM ALL POSITIONING BLOCKS USING CARPET PADDING OR HIGH DENSITY 1/2"THICK FELT MATERIAL. THE ENTIRE FRAMING CAVITY SURROUNDING THESE ELBOWS SHALL BE COMPLETELY PACKED WITH FIBERGLASS, OPEN FACED MINERAL WOOL OR SPRAY-ON ADHESIVE CELLULOSE INSULATION MATERIALS.

- NOTIFY WATER CO. OF PROPOSED NEW SERVICES TO EXISTING MAINS, AND PAY COST FOR METERS AND HOOKUP INSTALLATIONS.
- SLOPE ALL SOIL & WASTE LINES MIN. 2% SLOPE
- (1/4" PER FT.) UNLESS OTHERWISE INDICATED. DRAWINGS ARE DIAGRAMMATIC. DO NOT SCALE PLUMBING
- PLANS FOR EXACT HORIZONTAL LOCATION OF PIPE RUNS.
- SUPPLY ROUGH-IN, INSTALL AND CONNECT PLUMBING FIXTURES AS REQUIRED UNLESS OTHERWISE NOTED.
- PROVIDE AND INSTALL AN AUTOMATIC AIR VENT AT HIGH POINT OF ALL HOT WATER LINES.
- VERIFY & COORDINATE ROUGH-IN AND FIXTURE LOCATIONS WITH MECHANICAL DWGS. ARCHITECTURAL DWGS. PRIOR TO FABRICATION OR INSTALLATION OF
- MATERIALS AND AGAIN PRIOR TO SLAB POUR. VERIFY ALL ELECTRICAL CHARACTERISTICS WITH ELECTRICAL PLANS PRIOR TO BID OR MATERIAL PURCHASE.
- WORK SHALL NOT BE COVERED UNTIL IT HAS BEEN INSPECTED. TESTED AND APPROVED BY THE PLUMBING INSPECTOR OR OTHER GOVERNMENTAL AUTHORITIES HAVING
- PROVIDE ACCESS DOORS TO ALL CONCEALED VALVES. VALVES SHALL BE LINE SIZE UNLESS OTHERWISE NOTED.
- FLUSH VALVES, FAUCETS, STOPS, BUBBLERS, ETC., SHALL BE ADJUSTED TO THEIR NORMAL WORKING CONDITIONS.
- ALL LABOR AND MATERIALS SHALL BE GUARANTEED FOR ONE YEAR AFTER ACCEPTANCE OF THE COMPLETED WORK BY THE ARCHITECT, WITH SERVICE, REPLACEMENT OR REPAIR MADE AT NO EXTRA COST TO THE OWNER OR
- RECOMPACT ALL PLUMBING EXCAVATION.
- 13. ALL MATERIALS, EQUIPMENT, INSTALLATION, ETC., SHALL CONFORM TO ALL REQUIREMENTS OF ALL APPLICABLE CITY, COUNTY, STATE AND FEDERAL CODES, ORDINANCES
- VERIFY SIZE, LOCATION, DEPTH, ETC., OF ALL UTILITIES
- IN THE FIELD. FURNISH AND INSTALL ALL BACK FLOW PROTECTION AS REQUIRED BY STATE AND LOCAL HEALTH DEPT. AND
- PLUMBING CONTRACTOR TO FURNISH AND INSTALL ALL SUPPLIES, STOPS, TRAPS, VALVES, SHOCK-STOPS, REGULATORS AND BACK FLOW PROTECTION PER CODE TO OWNER'S FURNISHED SINKS AND EQUIPMENT.
- 17. PLUMBING CONTRACTOR TO SET IN PLACE ALL OWNER FURNISHED EQUIPMENT ON FIXTURE CONNECTION SCHEDULE AS DETAILED OR DIRECTED IN FIELD.
- 18. ALL SINKS AND LAVATORIES IN FOOD FACILITY AREAS SHALL BE SUPPLIED WITH A MIN. OF 120° F.
- 19. ALL WORK SHALL CONFORM TO ALL APPLICABLE CODES AND ORDINANCES, AND SHALL CONFORM TO THE
- CALIFORNIA PLUMBING CODE, LATEST EDITION. (2013) 20. ALL PIPING IN FINISHED AREAS SHALL BE CONCEALED WHERE POSSIBLE, AND EXPOSED PIPING SHALL BE
- RUN AS HIGH AS POSSIBLE AND TIGHT TO WALLS. REFER TO AIR CONDITIONING PLANS FOR DRAINS, ETC., FROM EQUIPMENT.
- INSULATE TAILPIECE, TRAP AND WATER LINES UNDER LAVATORIES DESIGNED FOR HANDICAP USE.
- 23. ALL INDIRECT DRAINS SHALL CONFORM TO CHAPTER 8, SECT. 803.0 CALIFORNIA PLUMBING CODE (2013).
- 24. THE PIPE SYSTEM SHALL BE FLUSHED WITH CLEAN. POTABLE WATER PER CHAPTER 6, SEC. 609.9 CALIFORNIA PLUMBING CODE (2013).
- ALL FIXTURES, EQUIPMENT, PIPING, FITTINGS, AND MATERIALS SHALL BE LISTED.
- 26. ALL PLUMBING FIXTURES SHALL MEET THE FLOW REQUIREMENTS SPECIFIED IN THE CALIFORNIA

PLUMBING CODE.

CONVEYING POTABLE WATER.

- 27. ALL FAUCETS IN PUBLIC RESTROOMS SHALL BE SELF-CLOSING OR SELF-CLOSING METERING FAUCETS.
- 28. PUBLIC LAVATORIES SHALL HAVE CONTROLS TO LIMIT THE WATER TEMPERATURE TO 120°.
- 29. WATER PIPE AND FITTINGS WITH A LEAD CONTENT WHICH EXCEEDS 0.25% SHALL BE PROHIBITED IN SYSTEMS
- THE PRESSURE REGULATING VALVE (PRV) SHALL BE INSTALLED AT ABOVE GRADE OR FINISHED FLOOR. THE PRV SHALL NOT BE INSTALLED IN A PIT WHERE IT CAN BECOME SUBMERGED IN WATER.

GENERAL NOTES

- 31. THE REDUCED PRESSURE BACKFLOW DEVICE (RP) SHALL BE INSTALLED AT LEAST 12 INCHES ABOVE GRADE OR FINISHED FLOOR. THE RP SHALL NOT BE INSTALLED IN A PIT WHERE IT CAN BECOME SUBMERGED IN WATER.
- 32. THE SEISMIC GAS SHUT-OFF VALVE SHALL BE MOUNTED RIGIDLY TO THE EXTERIOR OF THE BUILDING OR STRUCTURE CONTAINING THE FUEL GAS PIPING.
- 33. FOR NEWLY INSTALLED SHOWERHEADS, WHEN SINGLE SHOWER FIXTURES ARE SERVED BY MORE THAN ONE SHOWERHEAD, THE COMBINED FLOW RATE OF ALL THE SHOWERHEADS CONTROLLED BY A SINGLE VALVE SHALL NOT EXCEED THE MAXIMUM FLOW RATES SPECIFIED IN THE MAXIMUM ALLOWABLE FLOW RATE COLUMN CONTAINED IN TABLE 10.303.2.3 OR THE SHOWER SHALL BE DESIGNED ONLY ALLOW ONE SHOWERHEAD TO BE IN OPERATION AT A TIME.
- SITES THAT PROVIDE A WATER SERVICE UPGRADE AND CONTAIN AT LEAST 1,000 SQ.FT. OF CUMULATIVE LANDSCAPE AREAS BEING SERVED BY A POTABLE WATER SERVICE SHALL HAVE SEPARATE METERS OR SUB-METERS FOR INDOOR AND OUTDOOR POTABLE WATER USE.
- 35. NEW PLUMBING FIXTURES AND FITTINGS SHALL NOT EXCEED THE MAXIMUM ALOWABLE FLOW RATE SPECIFIED IN SECTION 5.303.2 AND TABLE 10.303.2.3
- 36. INSTALL WATER HAMMER ARRESTORS ON EACH COLD AND HOT WATER FIXTURE BRANCH AS RECOMMENDED BY PLUMBING AND DRAINAGE INSTITUTE WH-210 STANDARD. DEVICES SHALL BE FACTORY MADE WITH PERMANENT CUSHION OF GAS OR AIR. PROVIDE ACCESS PANEL.
- 37. GAS PIPING UNDERGROUND BENEATH BUILDING SHALL BE INSTALLED EITHER PER SECTION 1210.1.6.1 OR SECTION 1210.1.6.2 2013 CPC.
- 38. INSTALL CAST IRON PIPE, COPPER PIPE, AND FITTINGS BELOW GRADE INSIDE 8 MIL POLYETHYLENE TUBE PER AWWA-C-105 OR ANSI B215.
- 39. IT IS NOT INTENDED THAT THE DRAWINGS SHALL SHOW EVERY PIPE, FITTING, VALVE AND APPLIANCE. ALL SUCH ITEMS WHETHER SPECIFICALLY MENTIONED OR NOT, OR INDICATED ON THE DRAWINGS SHALL BE FURNISHED AND INSTALLED, IF NECESARY, TO COMPLETE THE SYSTEM IN ACCORDANCE WITH THE BEST PRACTICE OF THE PLUMBING TRADE AND TO THE SATISFACTION OF THE ENGINEER AND THE OWNER.
- 40. ALL FLOOR DRAINS AND FLOOR SINKS SHALL BE PROVIDED WITH TRAP PRIMER AND ACCESS PANEL.
- 41. ALL REQUIRED CLEANOUTS SHALL BE INSTALLED AS PER SEC. 707.0 &
- 719.0 OF THE CALIFORNIA PLUMBING CODE. 43. WATER CLOSET BOWLS FOR PUBLIC USE SHALL BE OF THE ELONGATED TYPE. 44. WATER SUPPLY CONNECTION TO COMMERCIAL DISHWASHING MACHINE SHALL BE

PROTECTED BY AN AIR GAP OR BACKFLOW PREVENTION DEVICE PER SECTION

- 603 OF THE CALIFORNIA PLUMBING CODE. 45. POTABLE WATER SUPPLY TO BEVERAGE DISPENSERS, CARBONATORS, OR COFFEE MACHINES SHALL BE PROTECTED BY AN AIR GAP OR A VENTED BACKFLOW PREVENTER IN ACCORDANCE WITH ASSE 1022.
- 46. ALL HOSE BIBBS SHALL BE EQUIPPED WITH AN APPROVED NON-REMOVABLE
- 47. NEW OR REPAIRED POTABLE WATER SYSTEM SHALL BE DISINFECTED PRIOR TO USE ACCORDING TO THE METHOD SET IN SECTION 609.9 OF THE PLUMBING CODE. 48. PUBLIC LAVATORIES SHALL HAVE A WATER TEMPERING DEVICE THAT COMPLIES W/
- ASSE 1070 OR CSA B125.3. 49. WATER PRESSURE ARRESTORS SHALL BE INSTALLED AS CLOSE AS POSSIBLE TO QUICK-ACTING VALVES AT THE END OF LONG PIPE OR NEAR BATTERIES OF
- FIXTURES OR BOTH. 50. HORIZONTAL VENTS BELOW THE THE FLOOD LEVEL RIM OF THE FIXTURE NOT ALLOWED FOR PLUMBING FIXTURES THAT ARE WITHIN TRAP ARM DISTANCE OF
- 51. ALL PIPING SHALL BE DEBURRED/REAMED TO FULL BORE OF PIPE.
- 52. NO MORE THAN ONE-THIRD (1/3) OF THE TOTAL PERMITTED LENGTH, PER 2019 CALIFORNIA PLUMBING CODE TABLE 703.2, OF ANY MINIMUM SIZED VENT SHALL BE INSTALLED IN A HORIZONTAL POSITION.
- 53. PLUMBING PENETRATIONS THROUGH OCCUPANCY SEPARATIONS SHALL BE BOXED OUT AND FILLED WITH APPROVED SAFING MATERIAL. INSULATION NOT APPROVED.
- 54. PLUMBING FIXTURES AND FITTINGS SHALL BE INSTALLED IN ACCORDANCE WITH THE CALIFORNIA PLUMBING CODE, AND SHALL MEET APPLICABLE STANDARDS REFERENCED IN TABLE 1701.1 OF THE CALIFORNIA PLUMBING CODE.
- 55. SHOWER TUB-SHOWER COMBINATION SHALL HAVE INDIVIDUAL SHOWER CONTROL VALVE OF THE PRESSURE BALANCE OR THERMOSTATIC MIXING VALVE TYPE, SET AT 120F MAXIMUM.
- 56, GAS METER SHALL BE INSTALLED PER GAS COMPANY AND PROTECTED PER GAS COMPANY AND OTHER LOCAL AUTHORITY

- 57. ALL FIXTURES, EQUIPMENT, PIPING, AND MATERIALS SHALL BE LISTED TO APPROVED STANDARDS BY AN RECOGNIZED THIRD-PARTY LISTING AGENCY. 58. ALL PLUMBING FIXTURES SHALL MEET THE FLOW REQUIREMENTS SPECIFIED
- IN THE CALIFORNIA PLUMBING CODE & CALGREEN CODE WHICHEVER IS STRINGENT. 59. ALL FAUCETS IN PUBLIC RESTROOMS SHALL BE SELF-CLOSING METERING FAUCETS.
- 60. PUBLIC LAVATORIES SHALL HAVE CONTROLS TO LIMIT THE WATER TEMPERATURE TO 110 DEGREE F.
- 61. WATER PIPE AND FITTINGS WITH A LEAD CONTENT WHICH EXCEEDS 0.25% SHALL BE PROHIBITED IN SYSTEMS CONVEYING POTABLE WATER.
- 62. LOCATIONS OF UTILITIES SHOWN ARE APPROXIMATE. CONTRACTOR SHALL VERIFY EXACT LOCATIONS AND DEPTHS OF UTILITIES PRIOR TO STARTING WORK OF THIS SECTION, MAKE REQUIRED ADJUSTMENTS TO CONNECT TO UTILITIES. IF INDICATED POINTS OF CONNECTION CANNOT BE MADE TO EXISTING UTILITIES AS FOUND, THE CONTRACTOR SHALL, BEFORE CONTINUING, NOTIFY THE ENGINEER PRIOR TO INSTALLING ANY WORK WHICH MAY BE AFFECTED.
- 63. IT SHALL BE THE CONTRACTORS RESPONSIBILITY TO VERIFY AVAILABLE SPACES FOR INSTALLING THE WORK.
- 64. COORDINATION: THE DRAWINGS ARE DIAGRAMMATIC & INTENDED TO SHOW SCOPE. CONTRACTOR SHALL COORDINATE HIS WORK WITH OTHER TRADES TO PROVIDE BEST
- ARRANGEMENT OF ALL DUCT, PIPES, CONDUIT, ETC. 65. PROVIDE FELT WITH METAL BACKING VIBRATION ISOLATION SLEEVES OR PADS AT ALL PIPE HANGERS OR SUPPORTS AND ALL POINTS WHERE PIPING COMES IN CONTACT WITH ANY PORTION OF THE STRUCTURE. APPLIES TO ALL WATER AND WASTE PIPING. PROVIDE FELT AROUND ALL PVC PIPING AT SUPPORTS FOR THERMAL EXPANSION.
- 66. ALL PIPES, DUCTS AND CONDUITS SHALL BE SUPPORTED AND BRACED PER "SMACNA" GUIDE LINES. 67. PLUMBERS TAPE WILL NOT BE ACCEPTED AS A PERMANENT SUPPORT FOR ANY PIPING
- OR DEVICES. 68. VALVES SHALL FULL FLOW 1/4 TURN BALL TYPE BY NIBCO, WATTS, CRANE, STOCKHAM OR EQUAL. SERVICE PRESSURE SHALL BE SUITABLE FOR SERVICE INTENDED. PROVIDE AND INSTALL IDENTIFICATION TAGS ON ALL VALVES.
- VALVES IN EXPOSED COMMON AREAS TO HAVE LOCKING HANDLES. NO IRON BODY VALVES WILL BE ACCEPTED.
- 69. PROVIDE AND INSTALL DIELECTRIC UNIONS BETWEEN ALL COPPER AND GALVANIZED & IRON PIPING & COMPONENTS. (AS WATTS, ZURN OR EQUAL). 70. PENETRATIONS IN WALLS, FLOORS, OR CEILINGS, WHICH REQUIRE PROTECTED OPENINGS SHALL BE FIRE-STOPPED. FIRE-STOPPING SHALL BE AN APPROVED MATERIAL, SECURELY INSTALLED AND CAPABLE OF MAINTAINING ITS INTEGRITY WHEN SUBJECTED TO THE TIME-TEMPERATURE CURVED OF SFM STD. # 12-43-3 AND STD. # 12-43-1. INSTALLATION INSTRUCTIONS SHALL BE MADE AVAILABLE TO THE INSPECTION AUTHORITY
- AND BE MAINTAINED AT THE JOB SITE. 71. PROVIDE WATERTIGHT FLASHING WHEREVER PIPES PASS THROUGH EXTERIOR WALLS, ROOF
- 72. WATER, SEWER, VENT, FIRE AND GAS PIPES THROUGH CONCRETE WALLS AND FLOORS SHALL HAVE PIPE-SLEEVES WITH NON COMBUSTIBLE SEALING.
- 73. ALL HOSE BIBBS SHALL BE EQUIPPED W/ AN APPROVED NON REMOVABLE VACUUM BREAKER.
- 74. RUN A FULL SIZE DRAIN LINE FROM WATER HEATERS TEMPERATURE AND PRESSURE RELIEF VALVE TO NEAREST FLOOR SINK OR TO AN APPROVED LOCATION.
- 75. PROVIDE ACCESS DOORS TO ALL CONCEALED VALVES, STRAINERS, TRAP PRIMERS, ETC. 76. ALL PIPING IN FINISHED AREAS SHALL BE RUN CONCEALED. EXPOSED PIPING, WHERE
- NECESSARY, SHALL RUN AS HIGH AS POSSIBLE AND TIGHT TO THE WALLS. 77. THE CONTRACTOR SHALL CONTACT THE ARCHITECT, ENGINEER OR OWNER PRIOR TO BIDDING FOR INTERPRETATIONS AND CLARIFICATIONS OF THE DESIGN AND INCLUDE IN HIS BID ALL COSTS TO MEET THE DESIGN INTENT. CLARIFICATIONS MADE BY THE ARCHITECT, ENGINEER OR
- OWNER AFTER BIDDING WILL BE FINAL AND SHALL BE IMPLEMENTED AT CONTRACTORS COST. 78. BIDDING CONTRACTORS SHALL HAVE A WORKING KNOWLEDGE OF LOCAL CODES AND ORDINANCES AND SHALL INCLUDE IN BIDS THE COSTS FOR ALL WORK INSTALLED IN STRICT ACCORDANCE WITH GOVERNING CODES, THE PLANS AND SPECIFICATIONS NOT WITHSTANDING. THE CONTRACTOR SHALL ALERT ARCHITECT, ENGINEER OR OWNER OF ANY APPARENT
- DISCREPANCIES BETWEEN GOVERNING CODES AND DESIGN INTENT. 79. THE CONTRACTOR SHALL FURNISH ALL LABOR, SUPERVISION, MATERIALS, EQUIPMENT & FACILITIES NECESSARY TO FURNISH, FABRICATE, DELIVER, STORE AND INSTALL ALL WORK NOTED ON THE DRAWINGS.
- THE CONTRACTOR SHALL FURNISH & INSTALL ALL WORK NECESSARY TO MAKE A COMPLETE SYSTEM WHETHER OR NOT SUCH DETAILS ARE MENTIONED IN THESE SPECIFICATIONS OR SHOWN ON THE PLANS, BUT WHICH ARE OBVIOUSLY NECESSARY TO MAKE A COMPLETE SYSTEM, EXCEPTING ONLY THOSE PORTIONS THAT ARE SPECIFICALLY MENTIONED HEREIN OR PLAINLY MARKED ON THE ACCOMPANYING
- 80. SEWER PIPE SIZES THAT ARE 3 INCHES OR SMALLER SHALL BE SLOPED AT 2% 81. IN ORDER TO MAINTAIN SLOPE OF HORIZONTAL DRAINAGE PIPING, DOUBLE COMBINATION FITTING IS NOT PERMITTED TO INSTALL IN HORIZONTAL POSITION. AS AN ALTERNATIVE,
- TWO COMBINATION WYE AND 1/8 BEND FITTINGS MAY BE USED. 82. NO VENT OUTLET SHALL TERMINATE CLOSER THAN FOUR FEET TO OR ONE FOOT ABOVE ANY DOOR, WINDOW OR GRAVITY AIR INTAKE, NOR CLOSER THAN TEN FEET TO OR THREE FEET

DRAWINGS AS BEING INSTALLED UNDER ANOTHER SECTION OF THE SPECIFICATION.

ABOVE ANY FORCED OR MECHANICAL AIR INTAKE. 83. TYPE B VENTS SHALL TERMINATE 2 FT. ABOVE OR 8 FT. AWAY FROM ANY VERTICAL SURFACE. 84. PROVIDE HIGH AND LOW COMBUSTION FOR THE WATER HEATERS AND ALL OTHER GAS BURNING APPLIANCES REQUIRING COMBUSTION AIR AS PER CODE. EXACT LOCATION


AND ROUTING TO BE APPROVED BY THE ARCHITECT AND AUTHORITIES HAVING JURISDICTION.

85. WATER HEATERS AND STORAGE TANKS SHALL BE SEISMICALLY BRACED.

NOTICE


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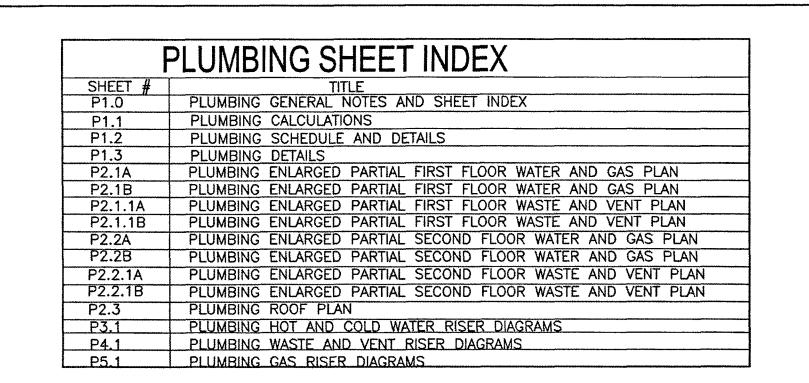
SEAL AND STAMP

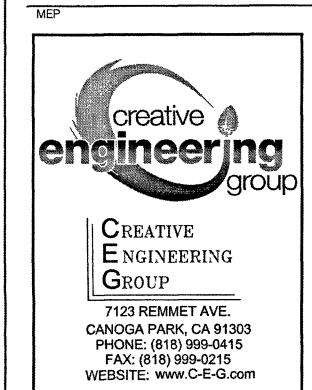

SCALE. AS SHOWN DRAWN. 02/28/2023 DATE: SHEET TITLE: **PLUMBING**

GENERAL

SHEET NO:

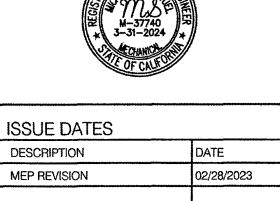

EXISTING(E) FIXTURES				······			
ROOMS-FIRST FLOOR (22) UNITS							
WASTE FIXTURE CALCU	LATION:	-				TOTAL	
(E)FIXTURE		NUMBER OF FIXTURES	X	FIXTURE UNITS	=	FIXTURE UNITS	•
WATER CLOSET (PRIVATE)		1	X	3	==	3	-
LAVATORY (PRIVATE) BATHTUB/SHOWER (PRIVATE	F)	1	X X	1 2	=	1 2	
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ROOMS-SECOND FLOOR (23) UNITS							
WASTE FIXTURE CALCU	LATION:						
<u> </u>	M: 111.751.11	NUMBER OF		FIXTURE		TOTAL FIXTURE	
(E)FIXTURE		FIXTURES	X	UNITS	=	UNITS	-
WATER CLOSET (PRIVATE) LAVATORY (PRIVATE)		1	X	3 1	-	3	
BATHTUB/SHOWER (PRIVATI	E)	1	Ŷ	2	=	2	
TOTAL WASTE FIXTURE UNI	rs —					<u> 6 TO</u>	TAI
EXISTING LAUNDRY-FIRST FLOOR							
(1) UNIT							
WASTE FIXTURE CALCU	LATION:	•				TOTAL	
(E)FIXTURE		NUMBER OF FIXTURES	X	FIXTURE UNITS	=	FIXTURE UNITS	
CLOTHES WASHER		1	X	52 (ASSU	ME) =	52	•
TOTAL WASTE FIXTURE UNIT	rs —	· · · · · · · · · · · · · · · · · · ·		(- 52 TO	TAI
(E)ROOMS CONVERTED TO ADA-FIF (2) UNITS-ROOMS 119 & 120	RST FLOOR						
<u>(2) UNITS-ROUNS TIS & 120</u> WASTE FIXTURE CALCU	I ATIONI.						
WASIE FIXTURE CALCO	LA HON:	NUMBER OF		FIXTURE		TOTAL FIXTURE	
(E)FIXTURE		FIXTURES OF	X	UNITS	=	UNITS	
WATER CLOSET (PRIVATE)		1	X	3	==	3	
LAVATORY (PRIVATE) SHOWER STALL (PRIVATE)		1 1	X X	1 2	=	1 2	
(CHANGED TUB/SHOWER TO		R STALL)	^	4			-
TOTAL WASTE FIXTURE UNIT						- 6 <u>TO</u>	TA
(F) TOTAL WASTE EIVTHINGS.							
(E) TOTAL WASTE FIXTURES:	,				TOTAL		
(E)FIXTURE	NUMBER FIXTURE	S OF X	FIXTURE UNITS		FIXTUF UNITS	₹Ł	
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FIRST FLOOR SECOND FLOOR	22	X	6	=	132		
EXISTING LAUNDRY	1	X	52	*****	52	3	
TOTAL EXISTING WASTE FIX	TURE UNI				****	TOTAL	
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(22) UNITS							
WASTE FIXTURE CALCU						TOTAL	
	LA HON:	•				11114	
	LA HON:	NUMBER OF	v	FIXTURE		FIXTURE	
(N)FIXTURE	LA HON:	NUMBER OF FIXTURES	X	UNITS	****	FIXTURE UNITS	-
(N)FIXTURE KITCHEN SINK (PRIVATE) TOTAL WASTE FIXTURE UNI		NUMBER OF	X X		=	FIXTURE	-
KITCHEN SINK (PRIVATE)		NUMBER OF FIXTURES		UNITS		FIXTURE UNITS 2	-
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KITCHEN SINK (PRIVATE) TOTAL WASTE FIXTURE UNIT RESTROOM (ADA)—FIRST FLOOR (1)—UNIT WASTE FIXTURE CALCU (N)FIXTURE WATER CLOSET (PUBLIC) LAVATORY (PUBLIC) TOTAL WASTE FIXTURE UNIT LAUNDRY—FIRST FLOOR (1)—UNIT WASTE FIXTURE CALCU (N)FIXTURE CLOTHES WASHER HAND SINK FLOOR DRAIN TOTAL WASTE FIXTURE UNIT ROOMS—SECOND FLOOR (23)—UNITS WASTE FIXTURE CALCU (N)FIXTURE KITCHEN SINK (PRIVATE) TOTAL WASTE FIXTURE UNIT LAUNDRY—SECOND FLOOR (1)—UNIT WASTE FIXTURE CALCU (N)FIXTURE FLOOR DRAIN TOTAL WASTE FIXTURE UNIT (NEW) TOTAL WASTE FIXTURE UNIT (NEW) TOTAL WASTE FIXTURE UNIT TOTAL WASTE FIXTURE UNIT (NEW) TOTAL WAS	TS — LATION: TS — LATION: TS — NUMBER FIXTURE 22 23 R'S 1 NOR 1 LOOR 1 LOOR 1 LOOR 1	NUMBER OF FIXTURES 1 NUMBER OF FIXTURES 1 1 NUMBER OF FIXTURES 2 1 1 NUMBER OF FIXTURES 2 1 1 NUMBER OF STATE OF STA	X X X X X X X X X X X X X X X X X X X	FIXTURE UNITS 3 2 6 FIXTURE UNITS 3 2 6	TOTAL FIXTUI UNITS 44	TOTAL FIXTURE UNITS 4 1 5 TOTAL FIXTURE UNITS 6 2 6 14 TOTAL FIXTURE UNITS 46 TOTAL FIXTURE UNITS 46 TOTAL FIXTURE UNITS 47 48 49 40 40 40 40 40 40 40 40 40 40 40 40 40	OTA OTA
KITCHEN SINK (PRIVATE) TOTAL WASTE FIXTURE UNIT RESTROOM (ADA)—FIRST FLOOR (1)—UNIT WASTE FIXTURE CALCU (N)FIXTURE WATER CLOSET (PUBLIC) LAVATORY (PUBLIC) TOTAL WASTE FIXTURE UNIT LAUNDRY—FIRST FLOOR (1)—UNIT WASTE FIXTURE CALCU (N)FIXTURE CLOTHES WASHER HAND SINK FLOOR DRAIN TOTAL WASTE FIXTURE UNIT ROOMS—SECOND FLOOR (23)—UNITS WASTE FIXTURE CALCU (N)FIXTURE KITCHEN SINK (PRIVATE) TOTAL WASTE FIXTURE UNIT LAUNDRY—SECOND FLOOR (1)—UNIT WASTE FIXTURE CALCU (N)FIXTURE FLOOR DRAIN TOTAL WASTE FIXTURE UNIT (N)FIXTURE FLOOR DRAIN TOTAL WASTE FIXTURE UNIT (N)FIXTURE FLOOR DRAIN TOTAL WASTE FIXTURE UNIT (NEW) TOTAL WASTE FIXTURES: (NEW)FIXTURE FIRST FLOOR SECOND FLOOR MANAGER'S LIVING QUARTER RESTROOM (ADA) STAFF OFFICE BREAK ROOM LAUNDRY ROOM—FIRST FLO LAUNDRY ROOM—SECOND FIRST TOTAL NEW WASTE FIXTURE	TS — LATION: TS — LATION: TS — NUMBER FIXTURE 22 23 R'S 1 NOR 1 LOOR 1 LOOR 1 LOOR 1	NUMBER OF FIXTURES 1 NUMBER OF FIXTURES 1 1 NUMBER OF FIXTURES 2 1 1 NUMBER OF FIXTURES 2 1 1 NUMBER OF STATE OF STA	X X X X X X X X X X X X X X X X X X X	FIXTURE UNITS 3 2 6 FIXTURE UNITS 3 2 6	= = = = = = = = = = = = = = = = = = =	TOTAL FIXTURE UNITS 4 1 5 TOTAL FIXTURE UNITS 6 2 6 1 TOTAL FIXTURE UNITS 46 46 TOTAL FIXTURE UNITS 6 A TOTAL FIXTURE UNITS 7 TOTAL FIXTURE UNITS 8 A TOTAL FIXTURE UNITS 9 A TOTAL FIXTURE UNITS 10 A TOTAL FI	OTA OTA
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KITCHEN SINK (PRIVATE) TOTAL WASTE FIXTURE UNIT RESTROOM (ADA)—FIRST FLOOR (1)—UNIT WASTE FIXTURE CALCU (N)FIXTURE WATER CLOSET (PUBLIC) LAVATORY (PUBLIC) TOTAL WASTE FIXTURE UNIT LAUNDRY—FIRST FLOOR (1)—UNIT WASTE FIXTURE CALCU (N)FIXTURE CLOTHES WASHER HAND SINK FLOOR DRAIN TOTAL WASTE FIXTURE UNIT ROOMS—SECOND FLOOR (23)—UNITS WASTE FIXTURE CALCU (N)FIXTURE KITCHEN SINK (PRIVATE) TOTAL WASTE FIXTURE UNIT LAUNDRY—SECOND FLOOR (1)—UNIT WASTE FIXTURE CALCU (N)FIXTURE FICOR DRAIN TOTAL WASTE FIXTURE UNIT WASTE FIXTURE CALCU (N)FIXTURE FLOOR DRAIN TOTAL WASTE FIXTURE UNIT (NEW) TOTAL WASTE FIXTURE UNIT (NEW) TOTAL WASTE FIXTURE UNIT (NEW) TOTAL WASTE FIXTURE FIRST FLOOR SECOND FLOOR MANAGER'S LIVING QUARTER RESTROOM (ADA) STAFF OFFICE BREAK ROOM LAUNDRY ROOM—FIRST FLO LAUNDRY ROOM—FIRST FLO LAUNDRY ROOM—FIRST FLO LAUNDRY ROOM—FIRST FLO LAUNDRY ROOM—SECOND F TOTAL NEW WASTE FIXTURE: BUILDING TOTAL WASTE FIXTURE	IS — ILATION: IS — ILATION:	NUMBER OF FIXTURES 1 NUMBER OF FIXTURES 1 1 NUMBER OF FIXTURES 2 1 1 NUMBER OF FIXTURES 2 1 1 NUMBER OF STATE O	X X X X X X X X X X X FIXTURE UNITS 2 2 11 5 2 8 6	FIXTURE UNITS 2 FIXTURE UNITS 3 2 6 FIXTURE UNITS 6	TOTAL FIXTUE UNITS TOTAL FIXTUE UNITS	TOTAL FIXTURE UNITS 4 1 5 TOTAL FIXTURE UNITS 6 2 6 14 TOTAL FIXTURE UNITS 46 46 TOTAL FIXTURE UNITS 46 47 48 49 40 40 40 40 40 40 40 40 40 40 40 40 40	OTA OTA
KITCHEN SINK (PRIVATE) TOTAL WASTE FIXTURE UNIT RESTROOM (ADA)—FIRST FLOOR (1)—UNIT WASTE FIXTURE CALCU (N)FIXTURE WATER CLOSET (PUBLIC) LAVATORY (PUBLIC) TOTAL WASTE FIXTURE UNIT LAUNDRY—FIRST FLOOR (1)—UNIT WASTE FIXTURE CALCU (N)FIXTURE CLOTHES WASHER HAND SINK FLOOR DRAIN TOTAL WASTE FIXTURE UNIT ROOMS—SECOND FLOOR (23)—UNITS WASTE FIXTURE CALCU (N)FIXTURE KITCHEN SINK (PRIVATE) TOTAL WASTE FIXTURE UNIT LAUNDRY—SECOND FLOOR (1)—UNIT WASTE FIXTURE CALCU (N)FIXTURE FLOOR DRAIN TOTAL WASTE FIXTURE UNIT WASTE FIXTURE CALCU (N)FIXTURE FLOOR DRAIN TOTAL WASTE FIXTURE UNIT (NEW) TOTAL WASTE FIXTURE UNIT (NEW) TOTAL WASTE FIXTURE UNIT (NEW) TOTAL WASTE FIXTURES: (NEW) TOTAL WASTE FIXTURE FIRST FLOOR SECOND FLOOR MANAGER'S LIVING QUARTER RESTROOM (ADA) STAFF OFFICE BREAK ROOM LAUNDRY ROOM—FIRST FLO LAUNDRY ROOM—SECOND F TOTAL NEW WASTE FIXTURE BUILDING TOTAL WASTE BUILDING TOTAL WASTE	IS — LATION: IS — LATION: IS — NUMBER FIXTURE 22 23 R'S 1 NOR 1 1 COR 1 E UNITS E FIXTU	NUMBER OF FIXTURES 1 NUMBER OF FIXTURES 1 NUMBER OF FIXTURES 2 1 1 NUMBER OF FIXTURES 2 1 1 NUMBER OF FIXTURES 2 1 1 R OF X X FIXTURE UNITS 2 2 11 5 2 8 6	FIXTURE UNITS 4 1 FIXTURE UNITS 2 FIXTURE UNITS 6 FIXTURE UNITS 6	TOTAL FIXTUE UNITS 44 45 1 5 2 TOTAL FIXTUE UNITS 44 45 1 5 6 7 TOTAL FIXTUE UNITS	TOTAL FIXTURE UNITS 4 1 5 TOTAL FIXTURE UNITS 6 2 6 14 TOTAL FIXTURE UNITS 6 46 TOTAL FIXTURE UNITS 6 6 7 10 TOTAL FIXTURE UNITS 10 TOTAL FIX	OTAL OTAL

EXISTING(E) FIXTURES ROOMS-FIRST FLOOR			······································		,,_,,	
(22) UNITS	581 .					
WATER FIXTURE CALCULATION		IBER OF	v	FIXTURE		TOTAL FIXTURE
(E)FIXTURE WATER OLOSET (PRIVATE)	FIXT	URES_	X X	<u>UNITS</u> 2.5	=	<u>UNITS</u> 2.5
WATER CLOSET (PRIVATE) LAVATORY (PRIVATE)		1	X	1	=	1
BATHTUB/SHOWER (PRIVATE) TOTAL WASTE FIXTURE UNITS		1	X 	4		<u>4</u> - 7.5 <u>T</u> 0
ROOMS-SECOND FLOOR						
(23) UNITS						
WATER FIXTURE CALCULATION		BER OF		FIXTURE		TOTAL FIXTURE
(E)FIXTURE	FIXT	<u>URES</u>	X	UNITS	==	UNITS
WATER CLOSET (PRIVATE) LAVATORY (PRIVATE)			X	2.5 1	=	2.5 1
BATHTUB/SHOWER (PRIVATE) TOTAL WASTE FIXTURE UNITS		1	X	4	=	+ <u>4</u> + 7.5 <u>10</u>
EXISTING LAUNDRY—FIRST FLOOR						
(1) UNIT						
WATER FIXTURE CALCULATION		BER OF		FIXTURE		TOTAL FIXTURE
(E)FIXTURE		URES	X	UNITS	= -	UNITS
CLOTHES WASHER		1	X	26 (ASSU	wc <i>)</i> =	26
TOTAL WASTE FIXTURE UNITS		***************************************				<u>26_TOTA</u>
(E)ROOMS CONVERTED TO ADA-FIRST FLO	OOR					
(2) UNITS-ROOMS 119 & 120 WATER FIXTURE CALCULATION)N·					_
	NUM	BER OF	X	FIXTURE	=	TOTAL FIXTURE
(E)FIXTURE WATER CLOSET (PRIVATE)	<u>FIXT</u>	URES 1	X	<u>UNITS</u> 2.5	=	<u>UNITS</u> 2.5
LAVATORY (PRIVATE) SHOWER STALL (PRIVATE)		1	X X	1 2	=	1 2
(CHANGED TUB/SHOWER TO SHO TOTAL WASTE FIXTURE UNITS	OWER STA	ALL)		R w		<u></u> 5.5 <u>TO</u>
						- 0.0 10
(E) TOTAL WATER FIXTURES:			- 1 ·-		TOTAL	_
(E)FIXTURE NUM	BER OF JRES	Χ	FIXTURE <u>UNITS</u>		FIXTUR UNITS	
	22	X	7.5		165	
SECOND FLOOR 2 EXISTING LAUNDRY	23 1	X X	7.5 26	-	172 26	
TOTAL EXISTING WATER FIXTURE	•	• •			***************************************	.5 <u>TOTAL</u>
NEW(N) FIXTURES						
ROOMS-FIRST FLOOR (22) UNITS						- · — — — — — — — — — — — — — — — — — —
WATER FIXTURE CALCULATION	ON:					TOTAL
(N)FIXTURE		IBER OF URES	X	FIXTURE UNITS	*****	FIXTURE UNITS
KITCHEN SINK (PRIVATE)		1	X	1.5	*****	1.5
TOTAL WATER FIXTURE UNITS						- 1.5 <u>TOT/</u>
PECTRANI (ANA), EIDET EI AAD						
RESTROOM (ADA)-FIRST FLOOR (1) UNIT						
WATER FIXTURE CALCULATION	ON:					TOTAL
(N)FIXTURE	NUM FIXT	IBER OF URES	Χ	FIXTURE UNITS	***	FIXTURE UNITS
WATER CLOSET (PUBLIC)	-121	1	X	2.5	=	2.5
LAVATORY (PUBLIC) TOTAL WATER FIXTURE UNITS		l 	X		=======================================	<u>1</u> → 3.5 <u>T</u> 0
LAUNDRY-FIRST FLOOR (1) UNLT						
WATER FIXTURE CALCULATION	ON:					TOTAL
(N)FIXTURE		IBER OF URES	X	FIXTURE UNITS	=	FIXTURE UNITS
CLOTHES WASHER		2	X	4	****	8
HAND SINK TOTAL WATER FIXTURE UNITS		1	X	1.5		$\frac{1.5}{9.5}$ TO
ROOMS-SECOND FLOOR (23) UNITS						TOTAL
	ON:			FUCTION		TOTAL FIXTURE
(23) UNITS WATER FIXTURE CALCULATION	NUM	BER OF	Y	FIXTURE	*****	<u>UNITS</u>
(23) UNITS WATER FIXTURE CALCULATION (N)FIXTURE	NUM	IBER OF URES 1	X X	UNITS 1.5	==	1.5
(23) UNITS WATER FIXTURE CALCULATION	NUM	<u>URES</u>		UNITS		1.5 - 1.5 <u>TOT</u>
(23) UNITS WATER FIXTURE CALCULATION (N)FIXTURE KITCHEN SINK (PRIVATE) TOTAL WATER FIXTURE UNITS	NUM	<u>URES</u>		UNITS		
(23) UNITS WATER FIXTURE CALCULATION (N)FIXTURE KITCHEN SINK (PRIVATE) TOTAL WATER FIXTURE UNITS (NEW) TOTAL WATER FIXTURES: NUM	NUM FIXT	<u>URES</u>	X	1.5	TOTAL FIXTUR	- 1.5 <u>101</u>
(23) UNITS WATER FIXTURE CALCULATION (N)FIXTURE KITCHEN SINK (PRIVATE) TOTAL WATER FIXTURE UNITS (NEW) TOTAL WATER FIXTURES: (NEW)FIXTURE NUM FIXTURE	NUM FIXT BER OF URES	URES_1	X FIXTURE UNITS	<u>UNITS</u> 1.5	TOTAL FIXTUF UNITS	- 1.5 <u>101</u>
WATER FIXTURE CALCULATION (N)FIXTURE KITCHEN SINK (PRIVATE) TOTAL WATER FIXTURE UNITS (NEW) TOTAL WATER FIXTURES: (NEW)FIXTURE FIRST FLOOR SECOND FLOOR	NUM FIXT	X X X	FIXTURE UNITS 1.5 1.5	<u>UNITS</u> 1.5	TOTAL FIXTUP UNITS 33 34.5	- 1.5 <u>TOT</u>
WATER FIXTURE CALCULATION (N)FIXTURE KITCHEN SINK (PRIVATE) TOTAL WATER FIXTURE UNITS (NEW) TOTAL WATER FIXTURES: (NEW)FIXTURE FIRST FLOOR SECOND FLOOR MANAGER'S LIVING QUARTER'S	BER OF URES	X X X X X	FIXTURE UNITS 1.5 1.5 1.5	<u>UNITS</u> 1.5	TOTAL FIXTUF UNITS 33 34.5 15.3	- 1.5 <u>TOT</u>
WATER FIXTURE CALCULATION (N)FIXTURE KITCHEN SINK (PRIVATE) TOTAL WATER FIXTURE UNITS (NEW) TOTAL WATER FIXTURES: (NEW)FIXTURE FIRST FLOOR	BER OF URES	X X X	FIXTURE UNITS 1.5 1.5	<u>UNITS</u> 1.5	TOTAL FIXTUP UNITS 33 34.5	- 1.5 <u>TOT</u>

EXISTING LAUNDRY-FIRST FLOOR (1) UNIT	
WATER FIXTURE CALCULATION:	
TOTAL WASTE FIXTURE UNITS	
(E)ROOMS CONVERTED TO ADA-FIRST FLOOR (2) UNITS-ROOMS 119 & 120	
WATER FIXTURE CALCULATION: (E)FIXTURE WATER CLOSET (PRIVATE) LAVATORY (PRIVATE) SHOWER STALL (PRIVATE) TOTAL FIXTURE FIXTURE UNITS 1 X 2.5 2.5 LAVATORY (PRIVATE) 1 X 2 2 (CHANGED TUB/SHOWER TO SHOWER STALL) TOTAL TOTAL TOTAL TOTAL FIXTURE UNITS 5.5 TOTAL	
(E) TOTAL WATER FIXTURES:	↓
$ \begin{array}{c ccccccccccccccccccccccccccccccccccc$	~ - · · · · · · · · · · · · · · · · · ·
NEW(N) FIXTURES ROOMS-FIRST FLOOR (22) UNITS WATER FIXTURE CALCULATION: (N)FIXTURE NUMBER OF X FIXTURE FIXTURE (N)FIXTURE VERY NUMBER OF X UNITS TOTAL FIXTURE (N)FIXTURE FIXTURE UNITS	
KITCHEN SINK (PRIVATE) 1 X 1.5 = 1.5 TOTAL WATER FIXTURE UNITS 1.5 TOTAL	
RESTROOM (ADA)—FIRST FLOOR (1) UNIT	•
WATER FIXTURE CALCULATION: (N)FIXTURE WATER CLOSET (PUBLIC) LAVATORY (PUBLIC) TOTAL FIXTURE FIXTURE FIXTURE FIXTURE FIXTURE FIXTURE FIXTURE 1 X 2.5 = 2.5 LAVATORY (PUBLIC) 1 X 1 TOTAL TOTAL	
LAUNDRY-FIRST FLOOR (1) UNLT WATER FIXTURE CALCULATION: NUMBER OF FIXTURE FIXTURE	
$ \begin{array}{c ccccccccccccccccccccccccccccccccccc$	
ROOMS-SECOND FLOOR (23) UNITS	
WATER FIXTURE CALCULATION: (N)FIXTURE (N)FIXTURE FIXTURES NUMBER OF X FIXTURE FIXTURE UNITS KITCHEN SINK (PRIVATE) 1 X 1.5 = 1.5 TOTAL WATER FIXTURE UNITS 1.5 TOTAL	
(NEW) TOTAL WATER FIXTURES: NUMBER OF FIXTURE FIXTURE	
(NEW)FIXTUREFIXTURESXUNITS=UNITSFIRST FLOOR22X1.5=33SECOND FLOOR23X1.5=34.5MANAGER'S LIVING QUARTER'S1X15.3=15.3STAFF OFFICE BREAKROOM1X1.5=1.5RESTROOM (ADA)1X3.5=3.5LAUNDRY ROOM—FIRST FLOOR1X9.5=9.5TOTAL NEW WATER FIXTURE UNITS99 TOTAL	PROJECT RESIDENTIAL AREA HOT WATER CALCULATION TOTAL%
BUILDING TOTAL WATER FIXTURE GRAND TOTAL WATER FIXTURE: TOTAL	FIXTURES OTY H.W.(F.U.) GPH EACH GPH DEMAND (%) = GPH SHOWER STALL 1 2 30 30 100% = 30
FIXTURENUMBER OF FIXTURESXFIXTURE UNITSFIXTURE UNITSEXISTING WATER FIXTURES1X363.5=363.5NEW WATER FIXTURES1X99=99	LAVATORY 2 2 2 4 100% = 4 KITCHEN SINK 47 70.5 10 470 30% = 141 CLOTHES WASHER 3 12 20 60 50% = 30 HAND SINK 2 3 10 20 30% = 6
GRAND TOTAL WATER FIXTURE UNITS462.5 TOTAL	TOTAL HOT WATER GPH 215 TO

215 GPH X 8.33# / GA. X 80/0.96 = 149,245.84 BTU/HR

ONE (1) A.O. SMITH MODEL BTH-150A, 150,000 BTU/HR INPUT,

DOMESTIC WATER HEATER 1. REQUIRED BTU/HR.

2. NEW WATER HEATER


	RESIDENTIAL COLD WATER D STREET MAIN TO PRV/LAST OUTLET	ESIGN
(A)	CONTACT: CALIFORNIA WATER SERVICE COMPANY (NATALIE)	PHONE: 831-385-5486
(B) (C) (D)	•	<u>95</u> F.U. <u>42</u> GPM
(E) (F) (G)	PRESSURE LOSS DUE TO HEIGHT 24 FT. x 0.433:	20.0 PSI 10.4 PSI 6.4 PSI
(H)	PRESSURE LOSS THRU 4" BACKFLOW PREVENTER:	_15.0_ PSI
(1)	TOTAL PRESSURE LOSS THRUPRESSURE REGULATION:	N/A PSI
(J)	TOTAL PRESSURE LOSS THRU - SUBMETER:	N/A PSI
(K)	TOTAL PRESSURE LOSS FROM ABOVE (ITEM E, THRU I):	<u>51.8</u> PSI
(L)	MINIMUM PRESSURE AVAILABLE: (ASSUME MINIMUM 60 PSI)	60 PSI
(M)	PRESSURE AVAILABLE FOR FRICTION LOSS (L-K):	_8.2 PSI
(N)	DEVELOPED PIPE LENGTH:	
	1. LENGTH OF RUN (MAIN TO LAST FIXTURE):	_500_ FT.
	2. EQUIVALENT LENGTH OF FITTINGS (25%):	<u>125</u> FT.
(0)	3. TOTAL DEVELOPED LENGTH:	<u>625</u> FT.
(0)	FRICTION LOSS PER ONE HUNDRED (100) FEET OF PIPE: 1: $100' \times (M) $ 8.2 DIVIDED BY (N) 625 =	1.3 PSI/100'

			OPPER						
	(COL	D WAT	ER)						
DI:	STRIBUT	ON PIPI	E SIZIN	G CHAR	I				
1.1	PSI/100) FT MA	XIMUM	FRICTIO	N LOSS	i			
MA	XIMUM V	VELOCIT	Y OF 6	FEET/	SECON	2			
PIPE	1/2"	3/4"	1"	1-1/4"	1-1/2"	2"	2-1/2"	3"	4"
GPM		3	5	9	15	31	55	88	185
FU		2	6	13	21	58	165	337	874
FV.		_	-	_	_	15	69	205	850
VEL		_			_		_	-	
	(HO	T WATE	<u>R)</u>						
DIS	STRIBUTI	ON PIPI	E SIZINO	G CHAR	I				
1.1	PSI/100) FT MA	XIMUM	FRICTIO	N LOSS	i			
	XIMUM \	T	T	FEET/	SECON				T
SIZE	1/2"	 	 	1-1/4"	 		2-1/2"		4"
GPM	-	3	5	9	15	31	55	88	185
FU FV		2	6	13	21	58	165	337	840
FU					_	_	~		_
VEL		_	_	-		_		_	
					A				
		<u>CF</u>	PVC PIPE	SIZING	CHARTS				
		(COL	D WATI	ER)					
	TRIBUTI	(COL	D WATI	ER) NG CHA	RI				
<u>1.1 F</u>	TRIBUTIO	(COL ON PIP	D WATI E SIZIN AXIMUM	ER) NG CHA I FRICT	ART TON LC) <u>SS</u>			
<u>1.1 F</u>	PSI/100 IMUM V	(COLON PIPOFT MA	D WATI E SIZIN AXIMUM Y OF (ER) NG CHA I FRICT 6 FEET D SDR11	ART TON LC / SECO	<u>PSS</u> <u>DND</u> *co	RZAN" CP	VC SCH.	80 DD 569
1.1 F	PSI/100	(COLON PIPOFT MA	D WATI E SIZIN AXIMUM Y OF (JARD GOLL L.A. TES	ER) NG CHA FRICT FEET SPR11 T LAB # F	ART TON LC / SECO	OSS OND "CO "HARVEL"	L.A. TES	VC SCH. T LAB #	80 RR-56
1.1 F MAX	PSI/100 IMUM V	(COL ON PIP FT M/ ELOCIT FLOWGL HARLOTTE"	D WATI E SIZIN AXIMUM Y OF (JARD GOLL L.A. TES	ER) NG CHA I FRICT 6 FEET D SDR11	ART TON LC / SECO	<u>PSS</u> <u>DND</u> *co	L.A. TES	T LAB #	80 RR-56
1.1 F MAX PIPE SIZE	"CH 3/4"	(COL ON PIP FT M/ ELOCIT FLOWGL HARLOTTE"	D WATI E SIZIN AXIMUM Y OF (JARD GOLL L.A. TES	ER) I FRICT 5 FEET C SDR11 T LAB # F	ART TON LC / SECO RR-5697 2"	OSS OND "CO "HARVEL" 2-1/2'	LA. TES	T LAB #	80 RR-56
1.1 F MAX PIPE SIZE GPM FT	"CH 3/4"	(COLON PIPO FT MAY (ELOCIT FLOWGU HARLOTTE" 1"	D WATI E SIZIN AXIMUM Y OF (IARD GOLL L.A. TES 1-1/4"	ER) NG CHA I FRICT 6 FEET D SDR11 T LAB # F 1-1/2"	ART TION LC / SECO RR-5697 2" 23	SS OND "CO "HARVEL" 2-1/2'	L.A. TES 3" 90	180	80 RR-569
PIPE SIZE GPM FT FU	"CH 3/4"	(COLON PIPO FT MAY (ELOCIT FLOWGU HARLOTTE" 1"	D WATI E SIZIN AXIMUM Y OF (IARD GOLL L.A. TES 1-1/4"	ER) NG CHA I FRICT 6 FEET D SDR11 T LAB # F 1-1/2"	ART ION LC / SECO RR-5697 2" 23 36	SS OND "CO "HARVEL" 2-1/2' 50 127	90 326	180 809	80 RR-56
PIPE SIZE GPM FT FU FV FU	2 1	(COLON PIPO FT MAY / ELOCIT FLOWGU HARLOTTE" 4 4 4	D WATI E SIZIN AXIMUM Y OF (JARD GOLL L.A. TES 1-1/4" 7 8	ER) NG CHA I FRICT 6 FEET D SDR11 T LAB # F 1-1/2"	ART HON LC / SECO RR-5697 2" 23 36 6 -	SS OND "CO "HARVEL" 2-1/2' 50 127	90 326	180 809	80 RR-56
PIPE SIZE GPM FT FU FV FU VEL	2 1 - <u>CP</u>	(COL ON PIP FT M/ FLOWGL HARLOTTE" 1" 4 4 VC PIP HOT WA	D WATI E SIZIN AXIMUM Y OF 6 JARD GOLL L.A. TES 1-1/4" 7 8 - E SIZIN TER)	ER) NG CHA I FRICT S FEET O SDR11 T LAB # F 1-1/2" 11 15	ART TON LC / SECO 2" 23 36 6 -	SS OND "CO "HARVEL" 2-1/2' 50 127	90 326	180 809	80 RR-56
PIPE SIZE GPM FT FU FV FU VEL	"CH 3/4" 2 1 - <u>CP</u> (H	(COL ON PIP FT M/ FLOWGL HARLOTTE" 1* 4 4	D WATI E SIZIN AXIMUM Y OF 6 JARD GOLL L.A. TES 1-1/4" 7 8 E SIZIN TER) E SIZIN	ER) NG CHA I FRICT S FEET O SDR11 T LAB # F 1-1/2" 11 15	ART TON LC / SECO RR-5697 2" 23 36 6 ARTS	2SS 2ND "CO "HARVEL" 2-1/2' 50 127 55 -	90 326	180 809	80 RR-56
PIPE SIZE GPM FT FU FV FU VEL DIST 1.0 P	2 1 - <u>CP</u>	(COL ON PIP FT M/ FLOCIT FLOWGL HARLOTTE" 1* 4 4	D WATI E SIZIN AXIMUM Y OF (JARD GOLL L.A. TES 1-1/4" 7 8 E SIZIN AXIMUM AXIMUM	ER) NG CHA I FRICT S FEET O SDR11 T LAB # F 1-1/2" 11 15	ART 10N LC / SECC RR-5697 2" 23 36 6 ARTS RI ION LO	SS DND "CO "HARVEL" 2-1/2' 50 127 55 -	90 326	180 809	80 RR-56
PIPE SIZE GPM FT FU FV FU VEL DIST 1.0 P	2 1 - CP RIBUTION RIBUTION MUM V	(COL ON PIP FT M/ FLOWGUA ARLOTTE" 1" 4 4 4 VC PIP IOT WA ON PIPE FT M/ ELOCITY FLOWGUA	D WATI E SIZIN AXIMUM Y OF 6 JARD GOLL LA. TES 1-1/4" 7 8 E SIZIN AXIMUM Y OF 6 RD GOLD	ER) NG CHA I FRICT S FEET O SDR11 T LAB # F 1-1/2" 11 15	ART JON LC / SECO RR-5697 2" 23 36 6	SS DND "CO "HARVEL" 2-1/2' 50 127 55 - SS ND "CORZA	90 326 224 -	180 809 800 	RR-56:
PIPE SIZE GPM FT FU FV FU VEL DIST 1.0 P	2 1 - CP RIBUTION RIBUTION MUM V	(COL ON PIP FT M/ FLOWGUA ARLOTTE" 1" 4 4 4 VC PIP IOT WA ON PIPE FT M/ ELOCITY FLOWGUA	D WATI E SIZIN AXIMUM Y OF 6 JARD GOLL L.A. TES 1-1/4" 7 8 - E SIZIN TER) SIZIN AXIMUM Y OF 6 RD GOLD L.A. TES	ER) NG CHA I FRICT S FEET S SDR11 T LAB # F 1-1/2* 11 15	ART JON LC SECO 2" 23 36 6 - ARTS RI JON LO SECO RR-5697	SS DND "CO "HARVEL" 2-1/2' 50 127 55 - SS ND "CORZA	90 326 224 - N* CPVC : LA. TES	180 809 800 	RR-56:
PIPE SIZE GPM FT FU FV FU VEL DIST 1.0 P MAXI	2 1 - CP RIBUTION RIBUTION MUM V "CH	(COL ON PIP FT M/ FLOWGU HARLOTTE" 1* 4 4 4	D WATI E SIZIN AXIMUM Y OF 6 JARD GOLL L.A. TES 1-1/4" 7 8 - E SIZIN TER) SIZIN AXIMUM Y OF 6 RD GOLD L.A. TES	ER) NG CHA I FRICT S FEET 1-1/2" 11 15	ART JON LC SECO 2" 23 36 6 - ARTS RI JON LO SECO RR-5697	SS DND "CO "HARVEL" 2-1/2' 50 127 55 - SS ND "CORZA "HARVEL"	90 326 224 - N* CPVC : LA. TES	180 809 800 SCH. 80	RR-56:
PIPE SIZE GPM FT FU FV FU VEL DIST 1.0 P MAXI PIPE SIZE	2 1 - CP (HERIBUTION MUM V "CHERIBUTION MUM V "CHERIBUTION MUM V "CHERIBUTION MUM V	(COL ON PIP FT M/ FLOWGUA HARLOTTE" 1" 4 4 4 VC PIP HOT WA ON PIPE FT M/ FLOWGUA HARLOTTE" 1"	D WATI E SIZIN AXIMUM Y OF 6 JARD GOLD L.A. TES 1-1/4" 7 8 - E SIZIN AXIMUM Y OF 6 RD GOLD L.A. TES 1-1/4"	ER) NG CHA I FRICT S FEET 1-1/2" 11 15 NG CHA FRICT FRICT FRICT SDR11 T LAB # F	ART JON LC SECO 2" 23 36 6 - ARTS RI JON LO SECO R-5697 2"	SS OND "CO "HARVEL" 2-1/2' 50 127 55 - SS OND "CORZA "HARVEL" 2-1/2'	90 326 224 - N* CPVC : LA. TES	180 809 800 SCH. 80 T LAB #	RR-56:
PIPE SIZE GPM FT FU VEL DIST 1.0 P MAXI PIPE SIZE GPM FT	2 1 - CP (HERIBUTION MUM V 3/4" 2 3/4" 2 3/4" 2	(COL ON PIP FT M/ /ELOCIT FLOWGL HARLOTTE 1" 4 4 VC PIP HOT WA ON PIPE FT M/ FLOCIT FLOWGUA HARLOTTE 1" 4	D WATI E SIZIN AXIMUM Y OF 6 IARD GOLL L.A. TES I—1/4" 7 8 — E SIZIN AXIMUM Y OF 6 RD GOLD L.A. TES I—1/4" 7	ER) NG CHA I FRICT S FEET O SDR11 T LAB # F 1-1/2" 11 15 NG CHA FRICT S FEET SDR11 T LAB # F 1-1/2" 11	ART ON LO SECO RR-5697 2" 23 36 6 - ARTS RI ON LO SECO RR-5697 2" 23	SS DND "CO "HARVEL" 50 127 55 - SS ND "CORZA "HARVEL" 2-1/2' 50	90 326 224 — N" CPVC S L.A. TES 3" 90	T LAB # 4" 180 809 800 SCH. 80 T LAB # 4" 180	RR-56:

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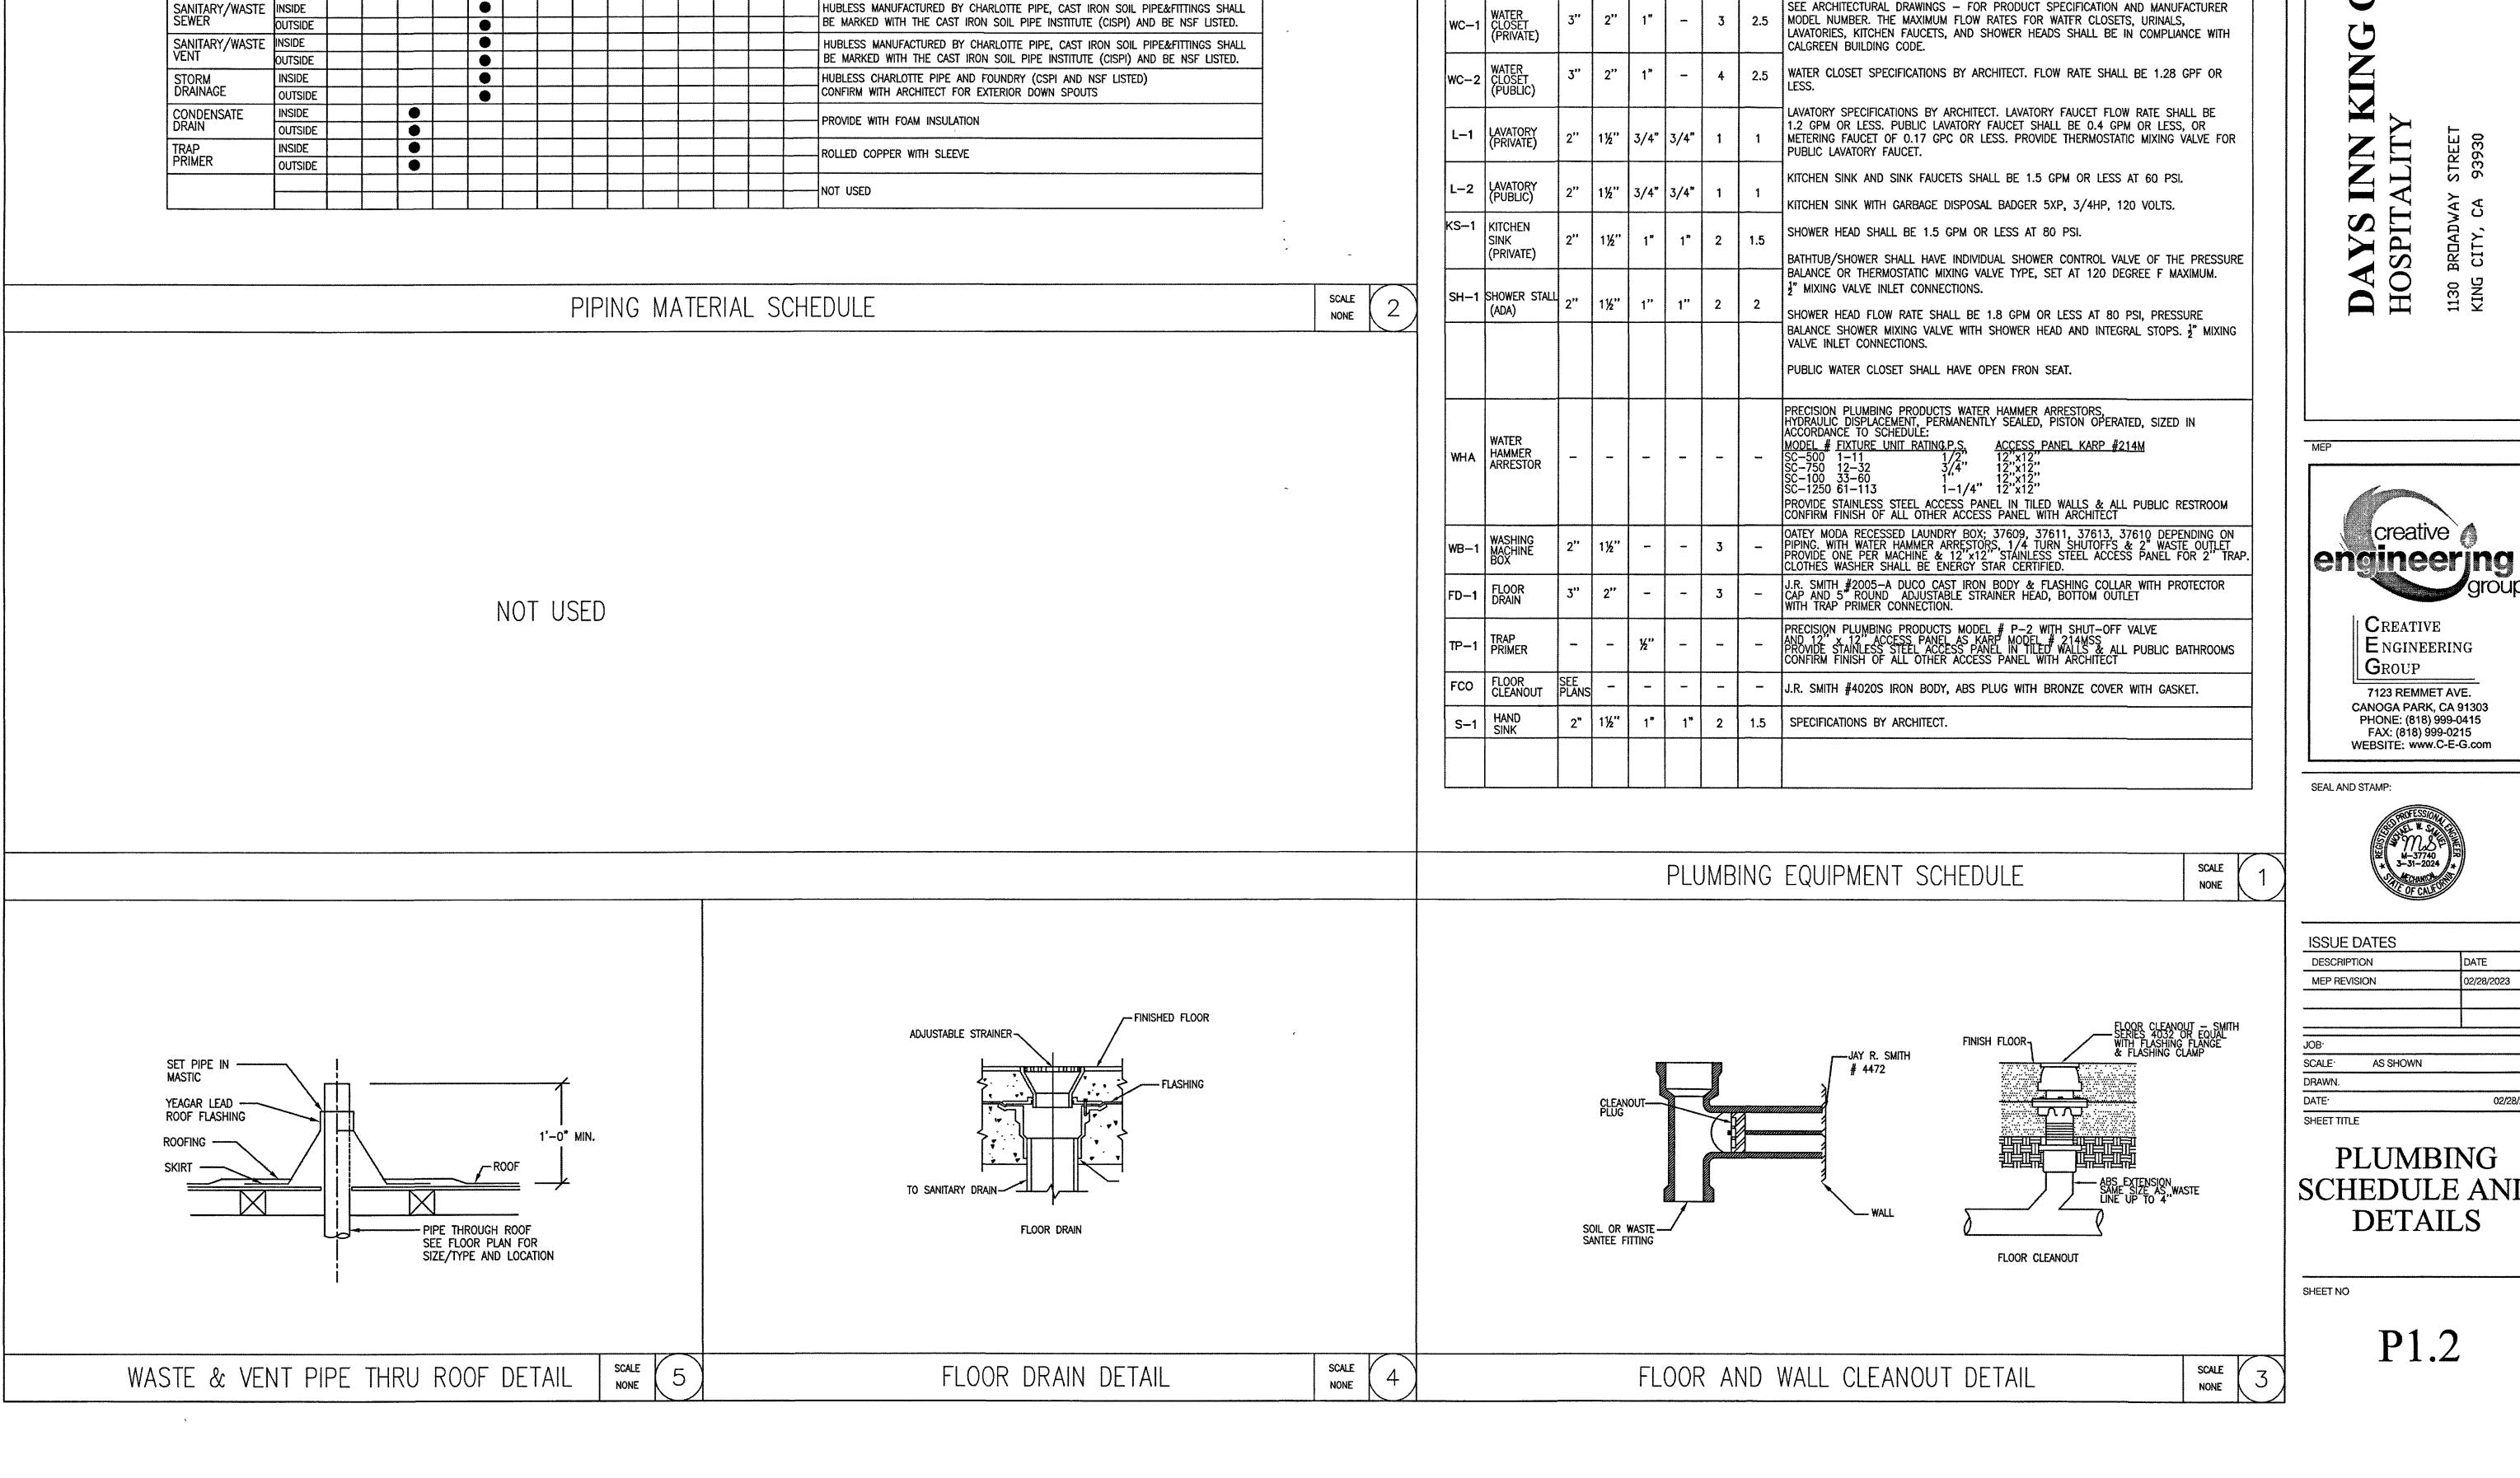
creative \ CREATIVE ENGINEERING GROUP 7123 REMMET AVE.
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ISSUE	DATES	
DESCRIP	TION	DATE
MEP REVI	SION	02/28/2023
JOB,		
SCALE	AS SHOWN	
DRAWN:		CE
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SHEET TITL	E.	

PLUMBING CALCULATION

P1.1

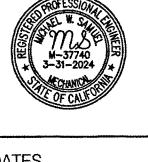

PIPING MATERIAL SCHEDULE

REMARKS

PIPING OUTDOOR AND ABOVE GROUND.

TYPE K BRAZED JOINTS FOR UNDER SLAB COPPER PIPING, DOUBLE WRAPPED W/

PLASTIC PIPE SHALL NOT BE INSTALLED EXPOSED TO THE SUNLIGHT.

SCOTCH TAPE & COVERED W/ FOAM INSULATION WHEN UNDER SLAB. COPPER TYPE L

CPVC PIPE MANUFACTURED BY CHARLOTTE PIPE LARR #5697 AND HARVEL LARR #5695. PROVIDE DOUBLE WALL PIPING W/VENTING WHEN INSTALLED UNDER SLAB. BLACK

MALLEABLE IRON FITTING. PIPE EXPOSED TO WEATHER SHALL BE GALVANIZED STEEL

BY CIVIL

• •

INS./A.G

OUT.S/A.G

INSIDE

OUTSIDE

COLD/HOT WATER INS./U.G

COLD/HOT WATER OUT.S/U.G

PLUMBING EQUIPMENT SCHEDULE

① ALL PLUMBING FIXTURES TO BE WHITE AND TRIM TO BE POLISHED CHROME FINISH UNLESS NOTED OTHERWISE.

② PROVIDE BRASSCRAFT KWIK TURN ANGLE STOPS FOR ALL FIXTURES. 3 PLUMBING FIXTURES AND TRIM SHALL BE AS NOTED OR EQUAL AND APPROVED BY OWNER.

(4) ALL HANDICAP LAVATORY & SINK TO BE PROVIDED WITH INSULATION FOR THE DRAIN & HOT WATER PIPING AS TRUEBRO KIT # 101 INSULATION KIT OR EQUAL.

(5) ALL PLUMBING FIXTURES TO BE APPROVED FOR USE IN KING CITY. (6) ALL PLUMBING FIXTURES MATERIAL, IAPMO LIST. MUST MEET WATER CONSERVATION ORDINANCE, MEET LOW LEAD REQUIREMENT (LESS THAN

0.25% WEIGHTED AVERAGE) O ALL PLUMBING FIXTURES SHALL MEET THE FLOW REQUIREMENTS SPECIFIED BY THE LOCAL AUTHORITY HAVING JURISDICTION.

® COORDINATE WITH THE ARCHITECT AND OWNERSHIP FINAL SPECIFICATION AND SIZES OF PLUMBING FIXTURES.

(9) CLOTHES WASHERS AND DISHWASHERS SHALL BE ENERGY STAR CERTIFIED.

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Ì	0	PLUMBING	FIXTURES	SHALL	COMPLY	WITH	2019	CPC	AND	MEET	THE	APPLICABLE	STANDARDS	IN	TABLE	1701.1.	

		PI	PING C	CONNEC	TION	FIXTUR	E UNITS	
ITEM	FIXTURE/ EQUIPMENT	SOIL OR WASTE	VENT	COLD WATER	HOT WATER	WASTE F.U.	COLD WATER F.U.	DESCRIPTION
WC-1	WATER CLOSET (PRIVATE)	3"	2"	1"	_	3	2.5	SEE ARCHITECTURAL DRAWINGS — FOR PRODUCT SPECIFICATION AND MANUMODEL NUMBER. THE MAXIMUM FLOW RATES FOR WATER CLOSETS, URINALS LAVATORIES, KITCHEN FAUCETS, AND SHOWER HEADS SHALL BE IN COMPLIA

ISSUE DATES DESCRIPTION MEP REVISION JOB. SCALE. AS SHOWN 02/28/2023

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PLUMBING SCHEDULE AND **DETAILS**

| CREATIVE

GROUP


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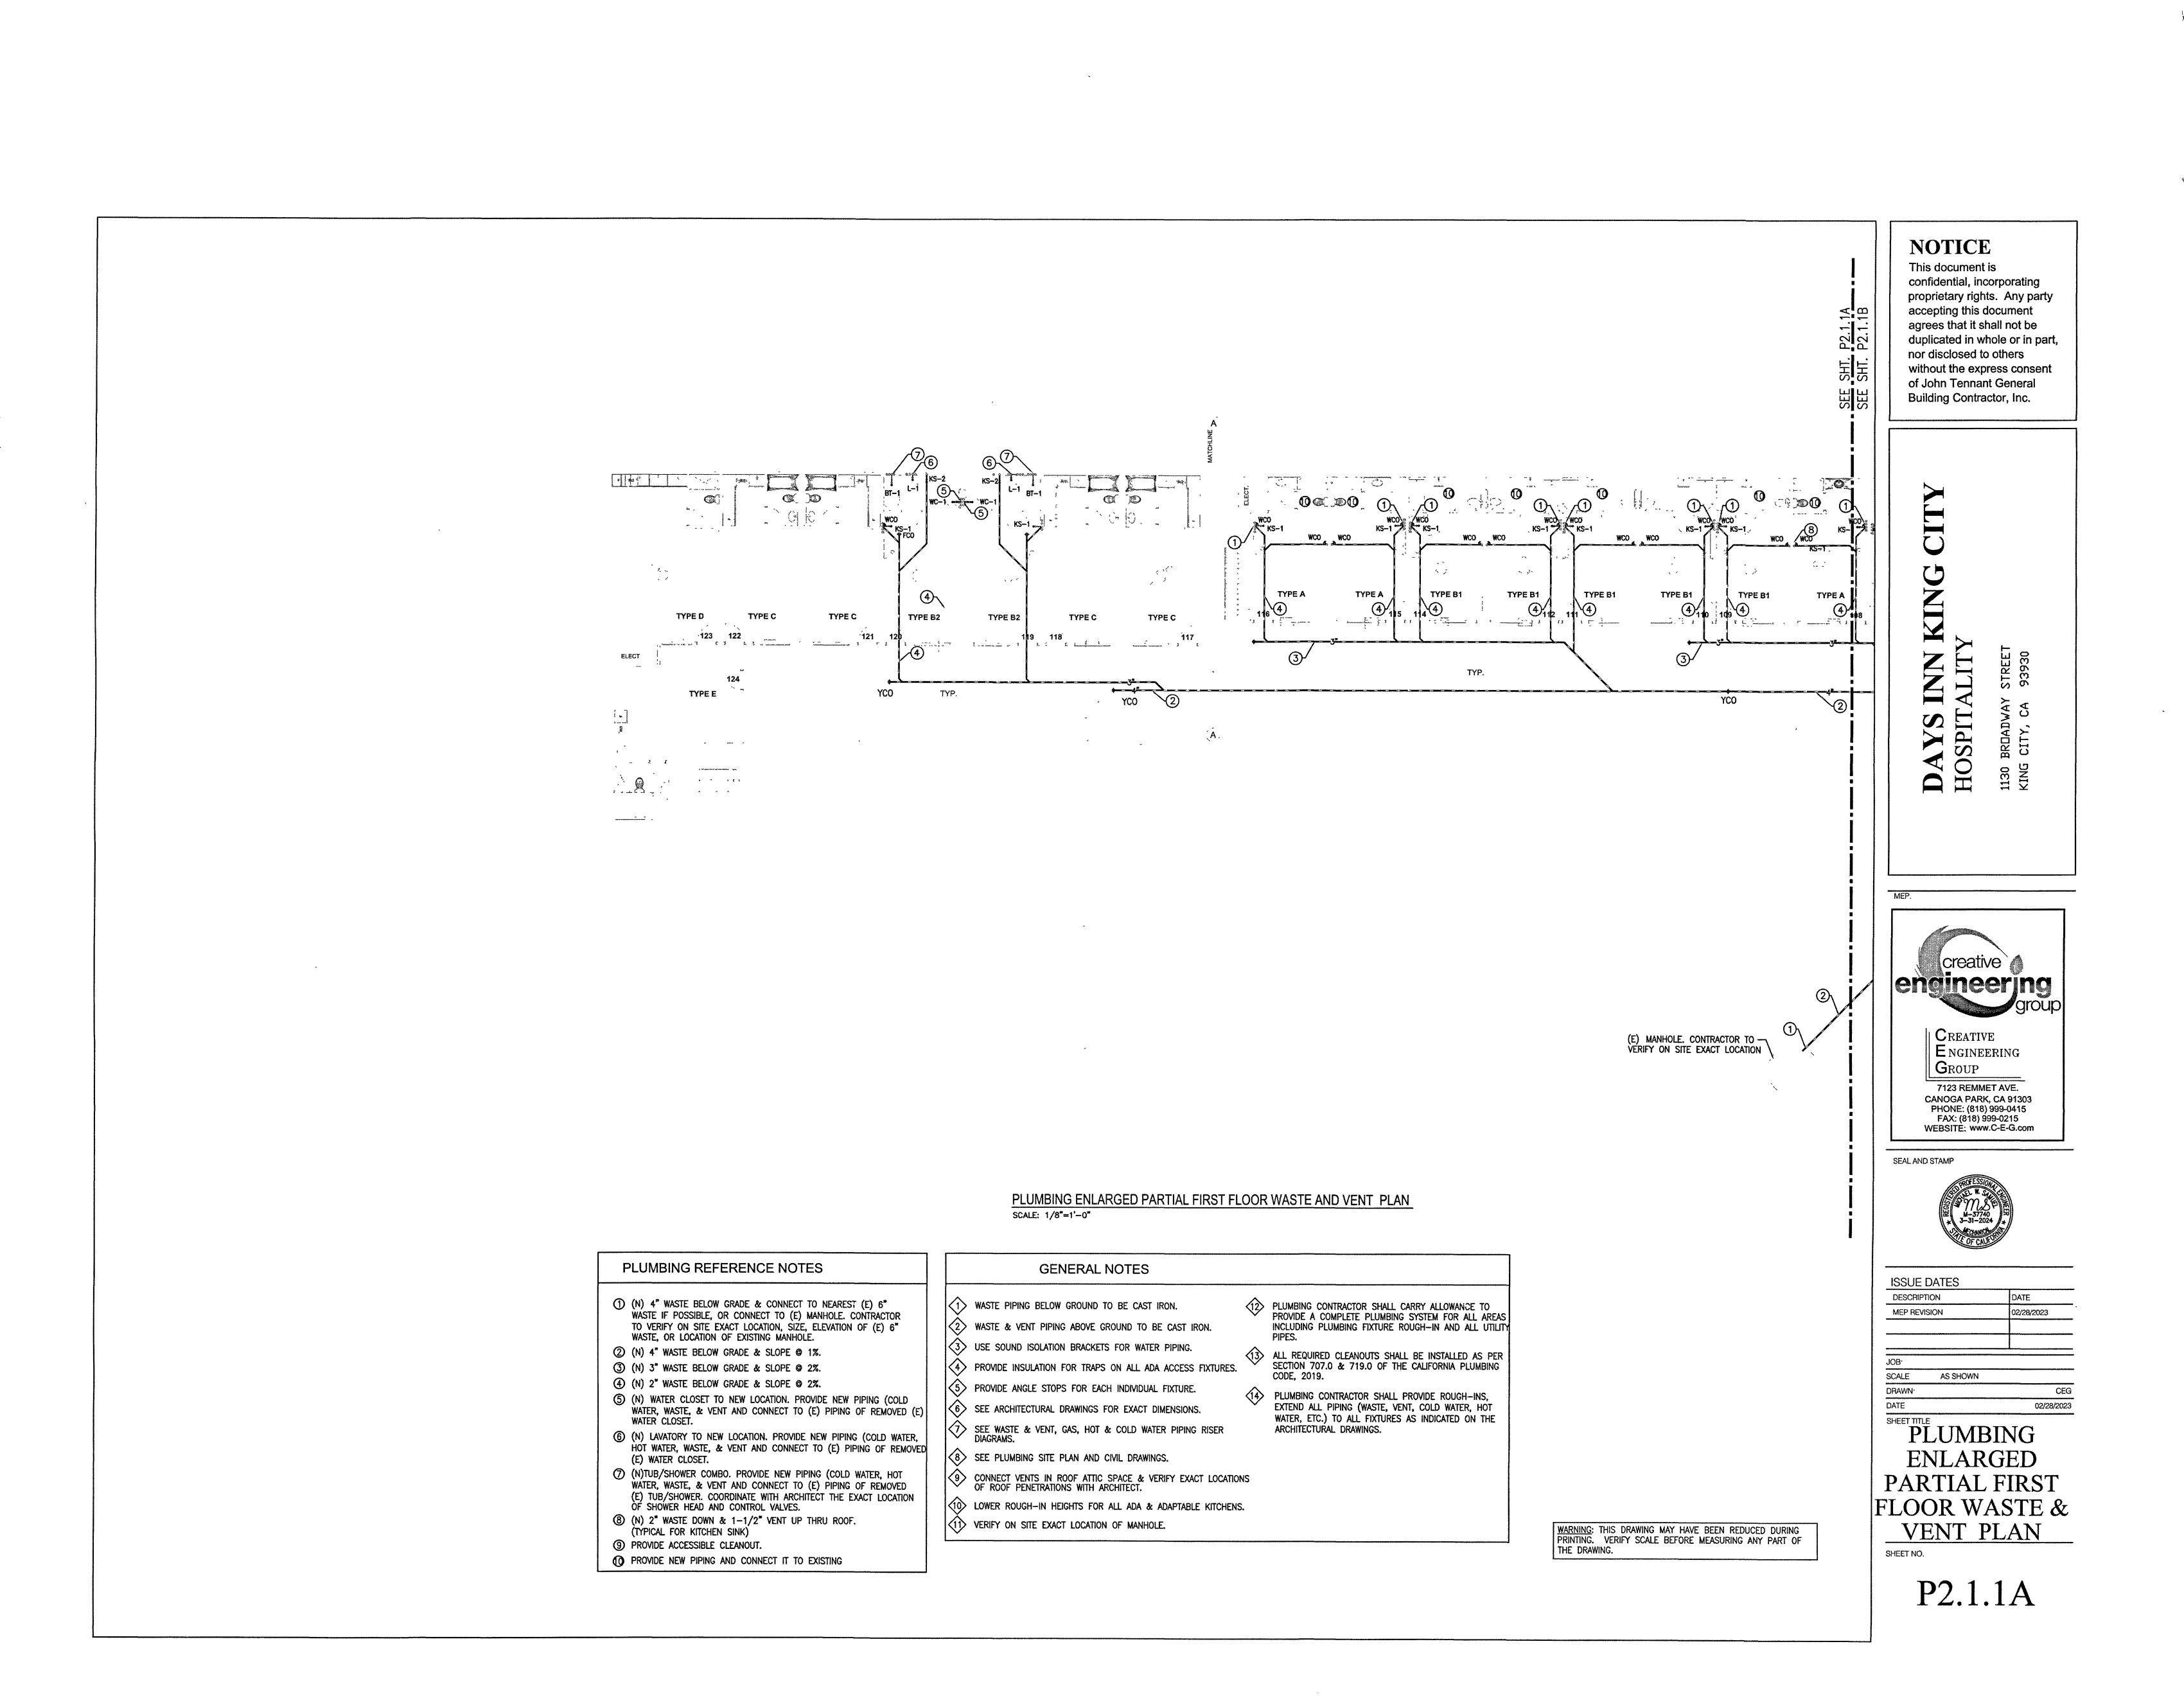
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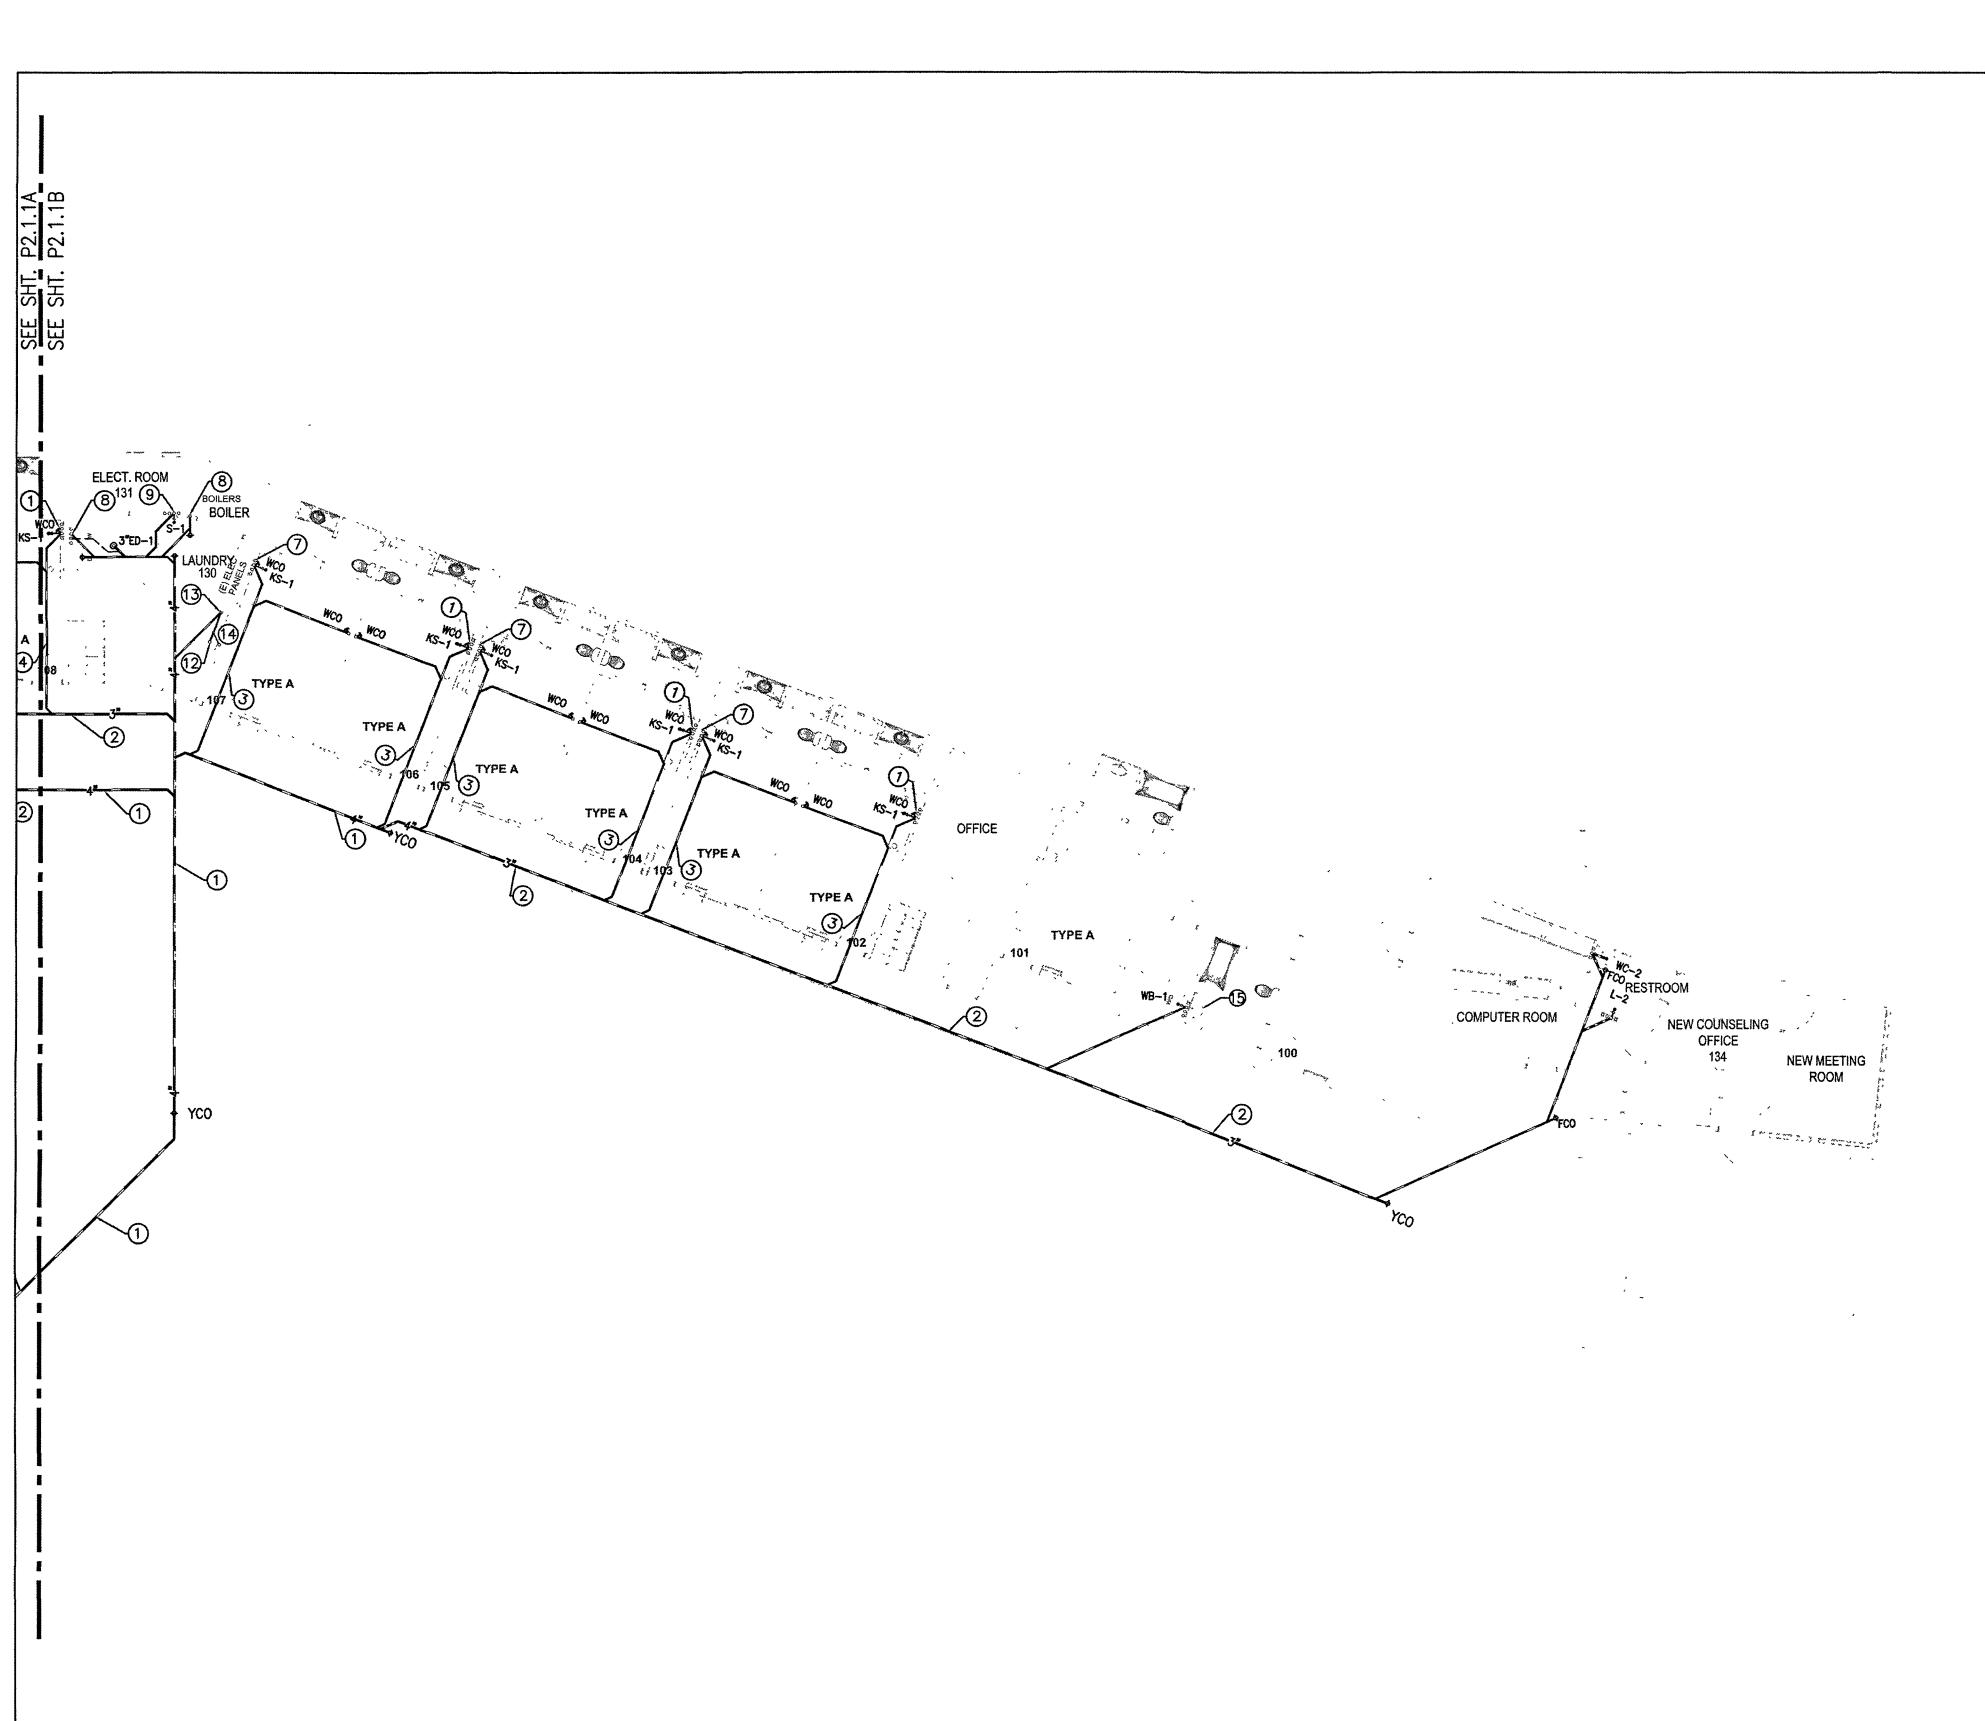
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SHEET NO

P1.2





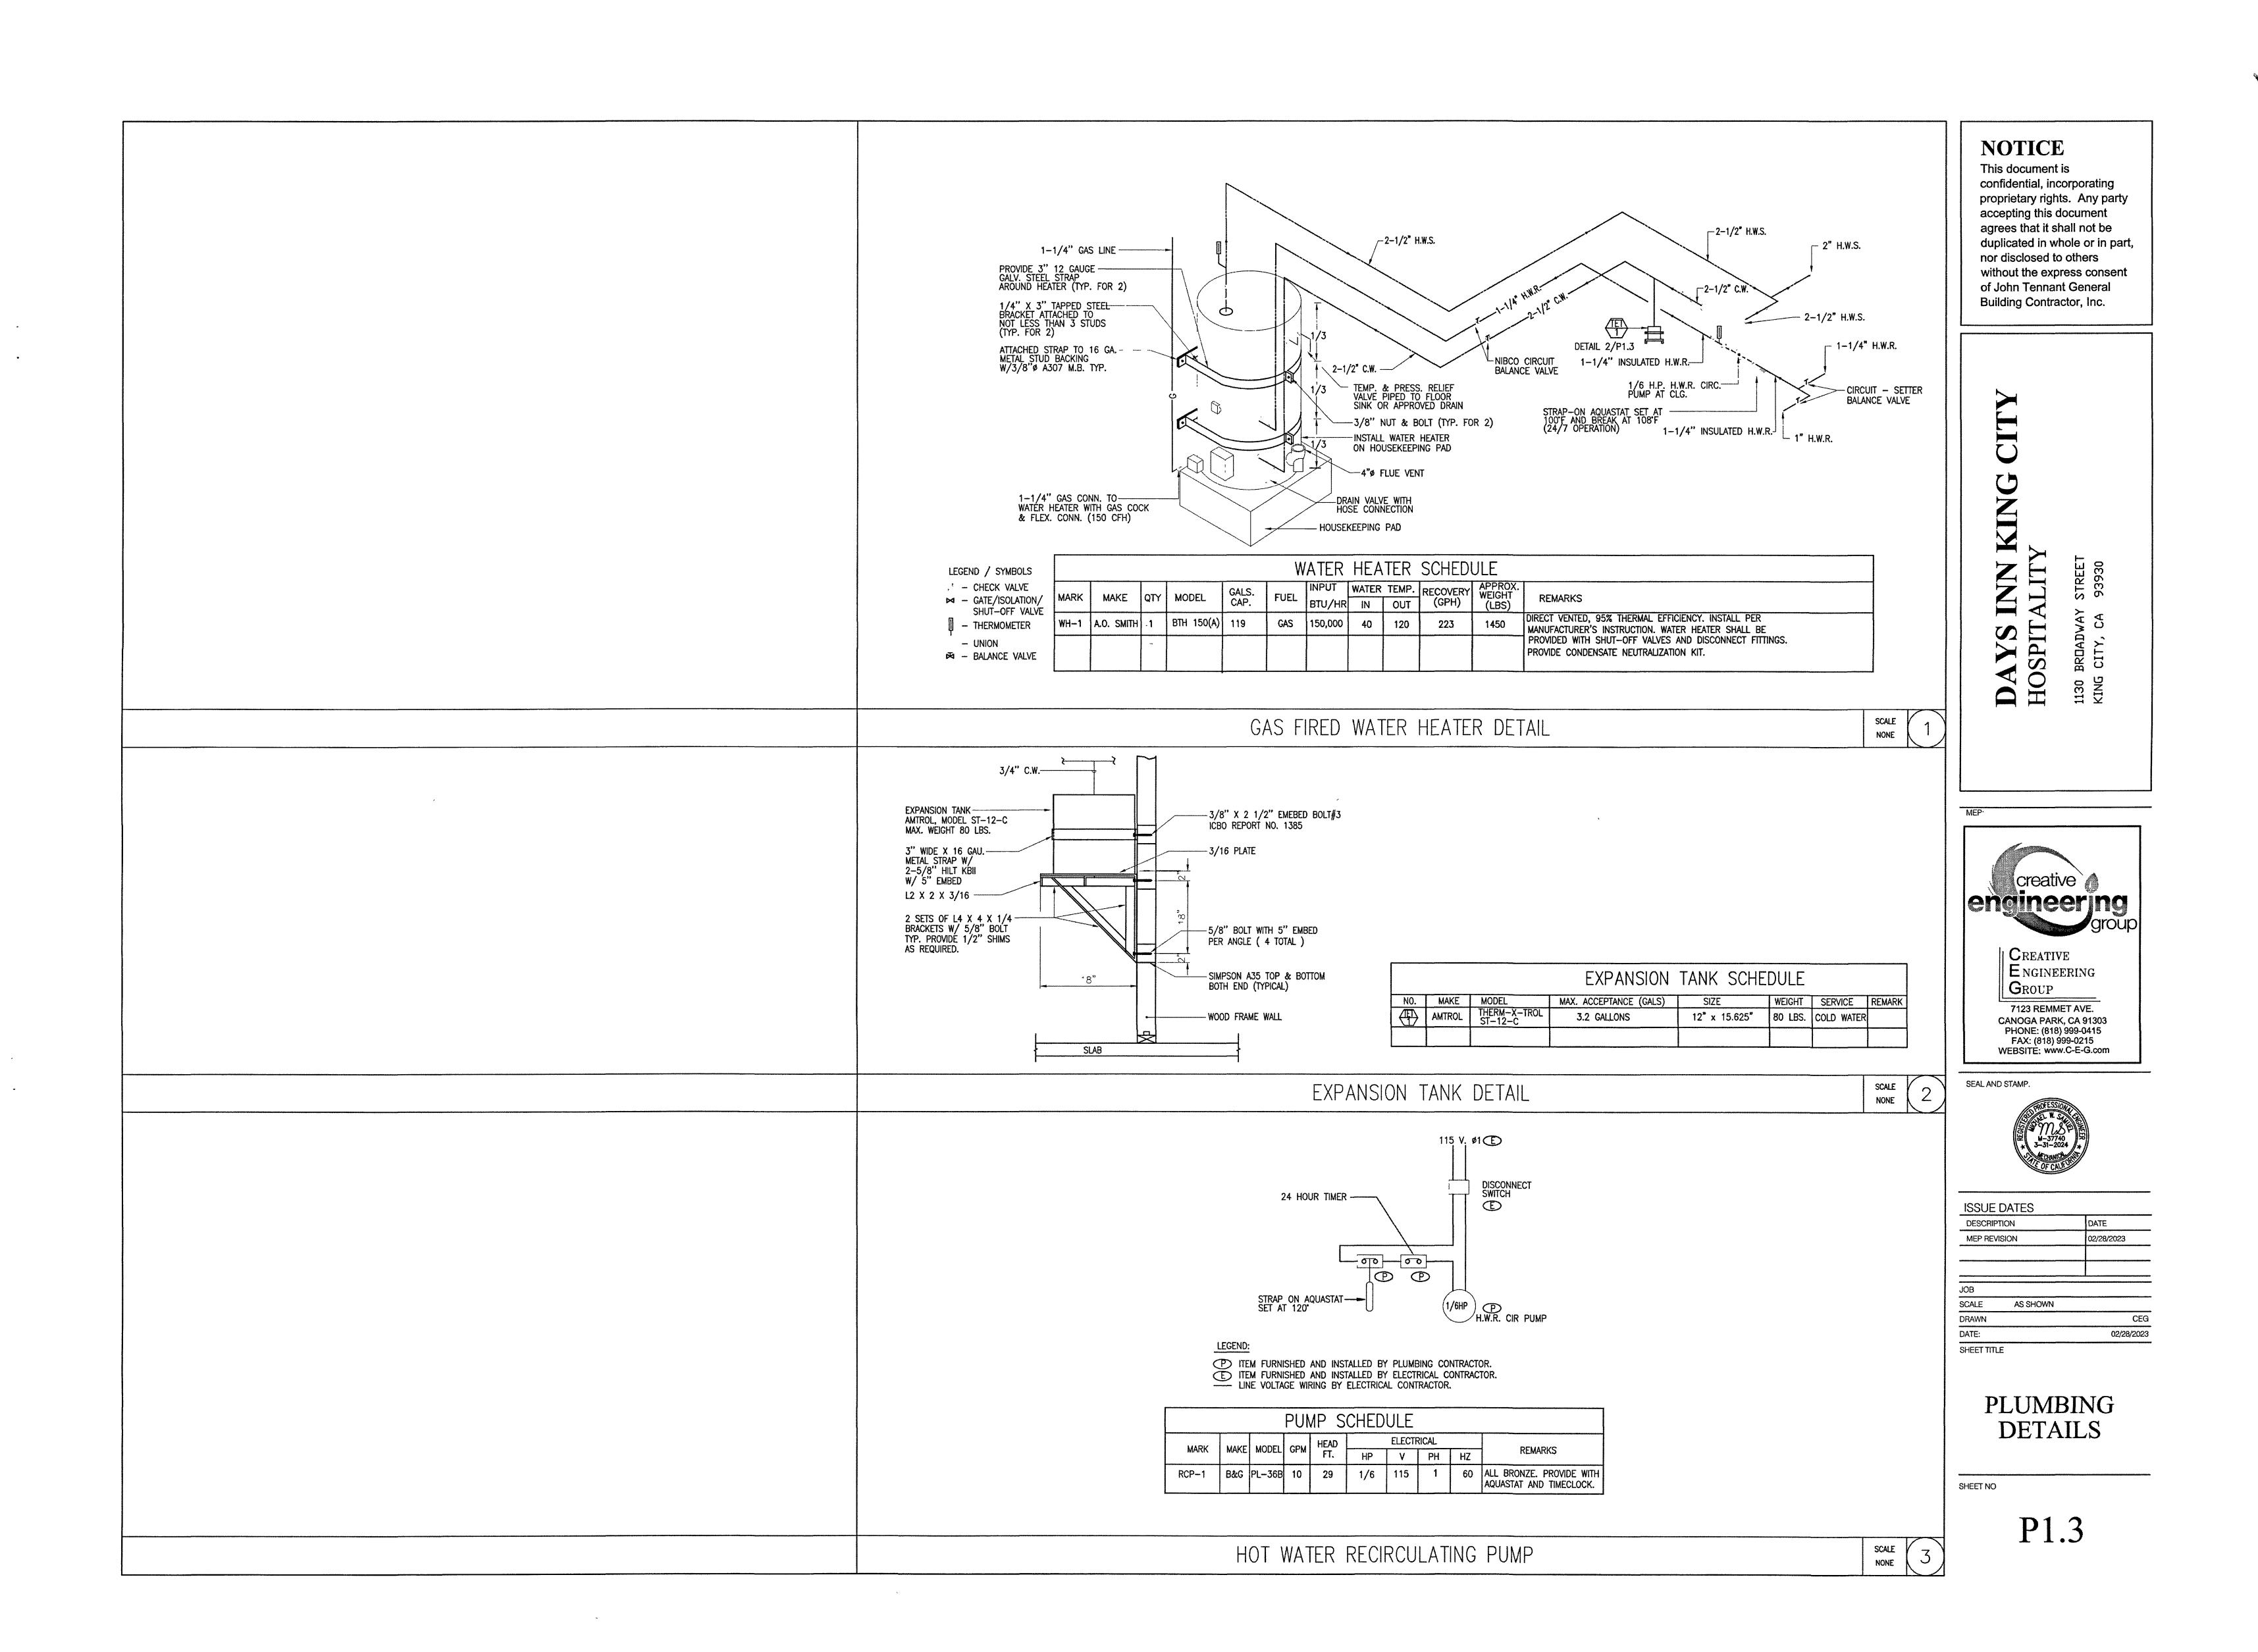

PLUMBING ENLARGED PARTIAL FIRST FLOOR WASTE AND VENT PLAN SCALE: 1/8"=1'-0"

PLUMBING REFERENCE NOTES

- (N) 4" WASTE BELOW GRADE & SLOPE @ 1%. ② (N) 3" WASTE BELOW GRADE & SLOPE @ 2%. (N) 2" WASTE BELOW GRADE & SLOPE @ 2%.
- (N) 3" WASTE DOWN & 2" VENT UP THRU ROOF.
 (TYPICAL FOR WATER CLOSET & MOP SINK) (N) 2" WASTE DOWN & 1-1/2" VENT UP THRU ROOF. (TYPICAL FOR LAVATORY)

(N) 3" WASTE FROM ABOVE.

(5) (E) LAVATORY TO BE RELOCATE.

- 6 (N) 2" WASTE DOWN & 1-1/2" VENT UP THRU ROOF. (TYPICAL FOR SHOWER STALL)
- (N) 2" WASTE DOWN & 1-1/2" VENT UP THRU ROOF. (TYPICAL FOR KITCHEN SINK)
- (N) 2" WASTE DOWN & 1-1/2" VENT UP THRU ROOF. (TYPICAL CLOTHES WASHER)
- (N) 2" WASTE DOWN & 1-1/2" VENT UP THRU ROOF.
- PROVIDE ACCESSIBLE CLEANOUT.
- CONNECT GARBAGE DISPOSAL TO SINK & CONNECT DISHWASHER TO GARBAGE DISPOSAL THROUGH APPROVED LEDGE MOUNTED AIR GAP FITTING ON SINK.

GENERAL NOTES

PLUMBING CONTRACTOR SHALL CARRY ALLOWANCE TO PROVIDE A COMPLETE PLUMBING SYSTEM FOR ALL AREAS INCLUDING PLUMBING FIXTURE ROUGH—IN AND ALL UTILITY

ALL REQUIRED CLEANOUTS SHALL BE INSTALLED AS PER SECTION 707.0 & 719.0 OF THE CALIFORNIA PLUMBING

PLUMBING CONTRACTOR SHALL PROVIDE ROUGH-INS, EXTEND ALL PIPING (WASTE, VENT, COLD WATER, HOT

WATER, ETC.) TO ALL FIXTURES AS INDICATED ON THE ARCHITECTURAL DRAWINGS.

PIPES.

CODE, 2019.

- (1) WASTE PIPING BELOW GROUND TO BE CAST IRON.
- (3) (N) 3" WASTE @ CEILING & DOWN BELOW GRADE. $\langle 2 \rangle$ waste & vent piping above ground to be cast iron. (N) 2" VENT & UP THRU ROOF. (3) USE SOUND ISOLATION BRACKETS FOR WATER PIPING.
 - PROVIDE INSULATION FOR TRAPS ON ALL ADA ACCESS FIXTURES.
 - 5> PROVIDE ANGLE STOPS FOR EACH INDIVIDUAL FIXTURE.
 - $\langle 6 \rangle$ see architectural drawings for exact dimensions.
 - SEE WASTE & VENT, GAS, HOT & COLD WATER PIPING RISER DIAGRAMS.
 - SEE PLUMBING SITE PLAN AND CIVIL DRAWINGS.
 - 9 CONNECT VENTS IN ROOF ATTIC SPACE & VERIFY EXACT LOCATIONS OF ROOF PENETRATIONS WITH ARCHITECT. 10 LOWER ROUGH—IN HEIGHTS FOR ALL ADA & ADAPTABLE KITCHENS.
 - (1) VERIFY ON SITE EXACT LOCATION OF MANHOLE.

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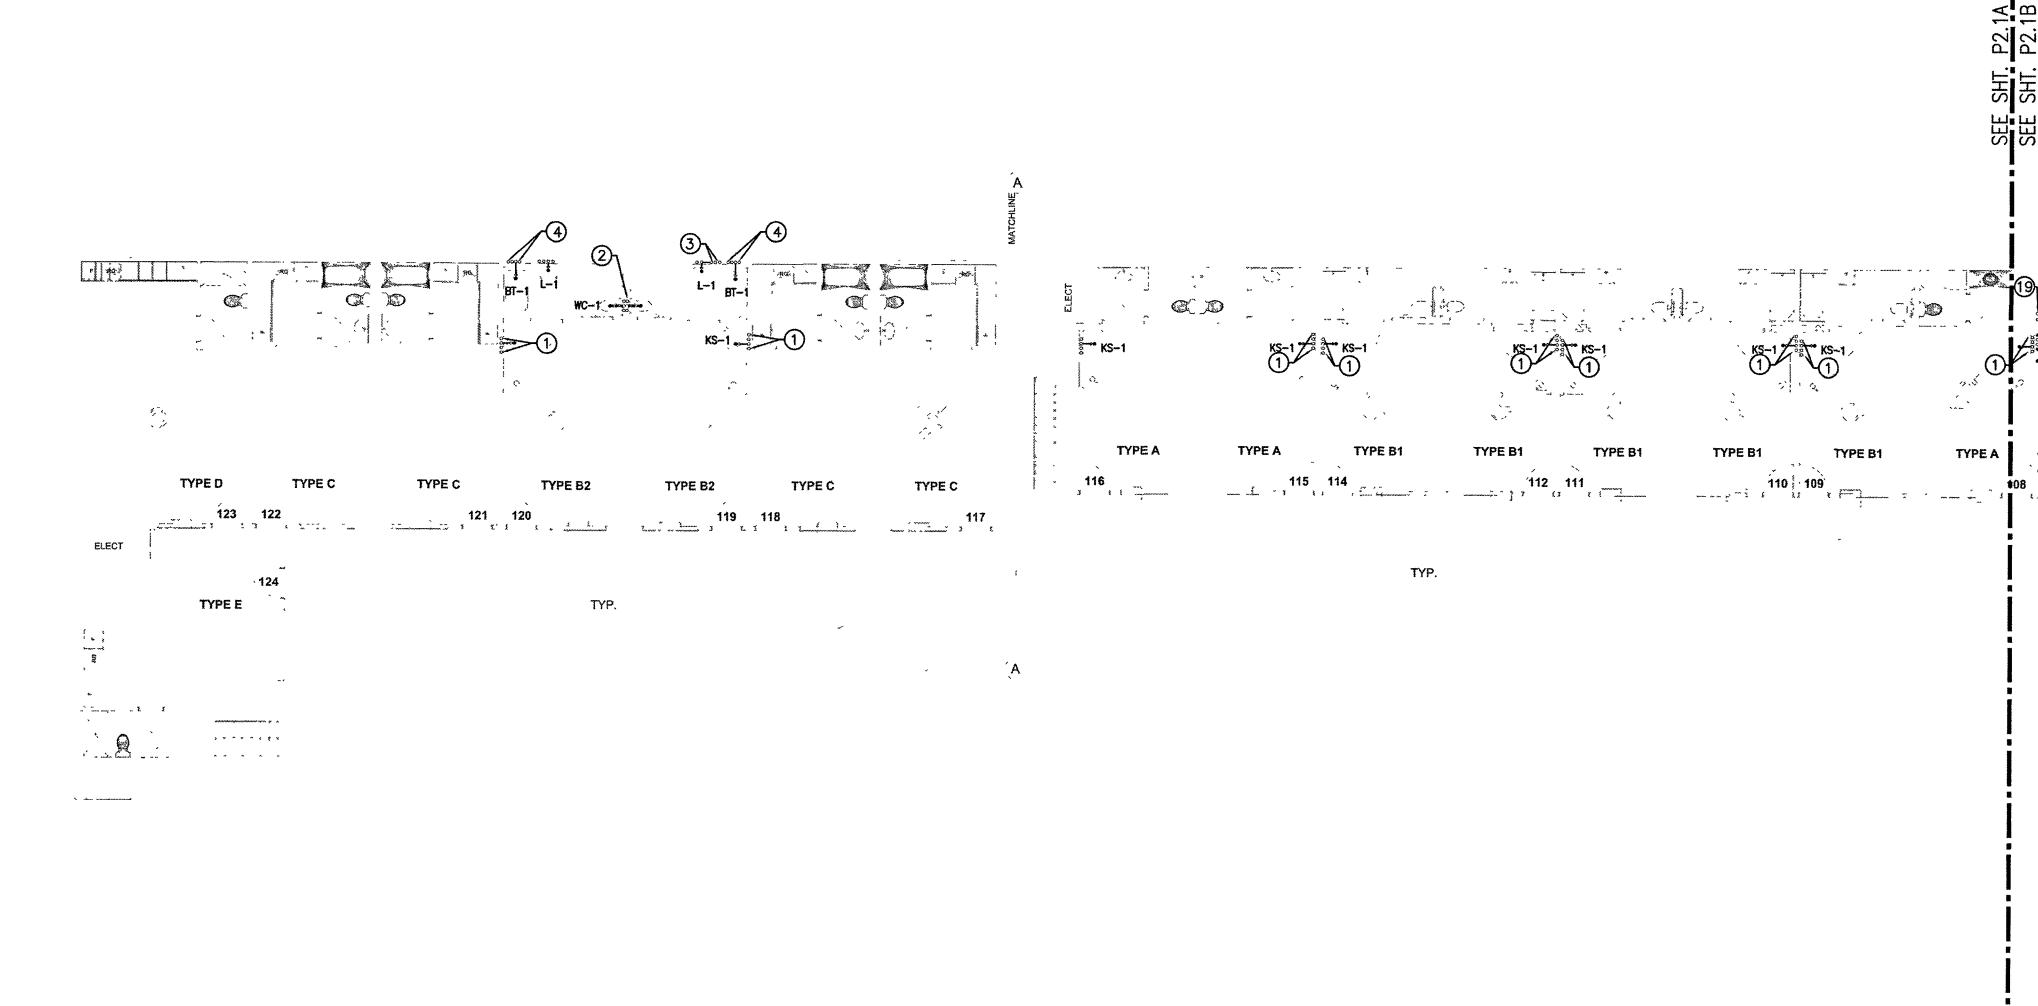
SEAL AND STAMP



ISSUE DATES DESCRIPTION DATE MEP REVISION 02/28/2023 SCALE⁻ AS SHOWN 02/28/2023

SHEET TITLE
PLUMBING **ENLARGED** PARTIAL FIRST FLOOR WASTE & VENT PLAN SHEET NO

P2.1.1B



(E) MANHOLE. CONTRACTOR TO VERIFY ON SITE EXACT LOCATION

PLUMBING CONTRACTOR SHALL CARRY ALLOWANCE TO PROVIDE A COMPLETE PLUMBING SYSTEM FOR ALL AREAS INCLUDING PLUMBING FIXTURE ROUGH—IN AND ALL UTILITY

ALL REQUIRED CLEANOUTS SHALL BE INSTALLED AS PER SECTION 707.0 & 719.0 OF THE CALIFORNIA PLUMBING CODE, 2019.

PLUMBING ENLARGED PARTIAL FIRST FLOOR WATER AND GAS PLAN SCALE: 1/8"=1'-0"

PLUMBING REFERENCE NOTES

- 1" COLD WATER & 1" HOT WATER SUPPLY FROM ABOVE & DOWN TO KITCHEN SINK. SEE HOT & COLD WATER RISER DIAGRAMS. (TYPICAL)
- ② EXTEND COLD WATER PIPING FROM REMOVED (E) WATER CLOSET. 3 EXTEND HOT & COLD WATER PIPING FROM REMOVED (E) LAVATORY.
- (4) EXTEND HOT & COLD WATER PIPING FROM REMOVED (E) TUB/SHOWER. REFER TO ARCHITECT & ADA REQUIREMENTS OF EXACT LOCATION OF SHOWER HEAD, VALVES, AND CONTROLS.

GENERAL NOTES

- (1) WASTE PIPING BELOW GROUND TO BE CAST IRON. 2 WASTE & VENT PIPING ABOVE GROUND TO BE CAST IRON.
- 3 USE SOUND ISOLATION BRACKETS FOR WATER PIPING. PROVIDE INSULATION FOR TRAPS ON ALL ADA ACCESS FIXTURES.
- 5 PROVIDE ANGLE STOPS FOR EACH INDIVIDUAL FIXTURE. 6 SEE ARCHITECTURAL DRAWINGS FOR EXACT DIMENSIONS.
- 5 SEE WASTE & VENT, GAS, HOT & COLD WATER PIPING RISER DIAGRAMS. SEE PLUMBING SITE PLAN AND CIVIL DRAWINGS.
- © CONNECT VENTS IN ROOF ATTIC SPACE & VERIFY EXACT LOCATIONS OF ROOF PENETRATIONS WITH ARCHITECT.
- 10 LOWER ROUGH-IN HEIGHTS FOR ALL ADA & ADAPTABLE KITCHENS.
- 11> VERIFY ON SITE EXACT LOCATION OF MANHOLE.

WARNING: THIS DRAWING MAY HAVE BEEN REDUCED DURING PRINTING. VERIFY SCALE BEFORE MEASURING ANY PART OF THE DRAWING.

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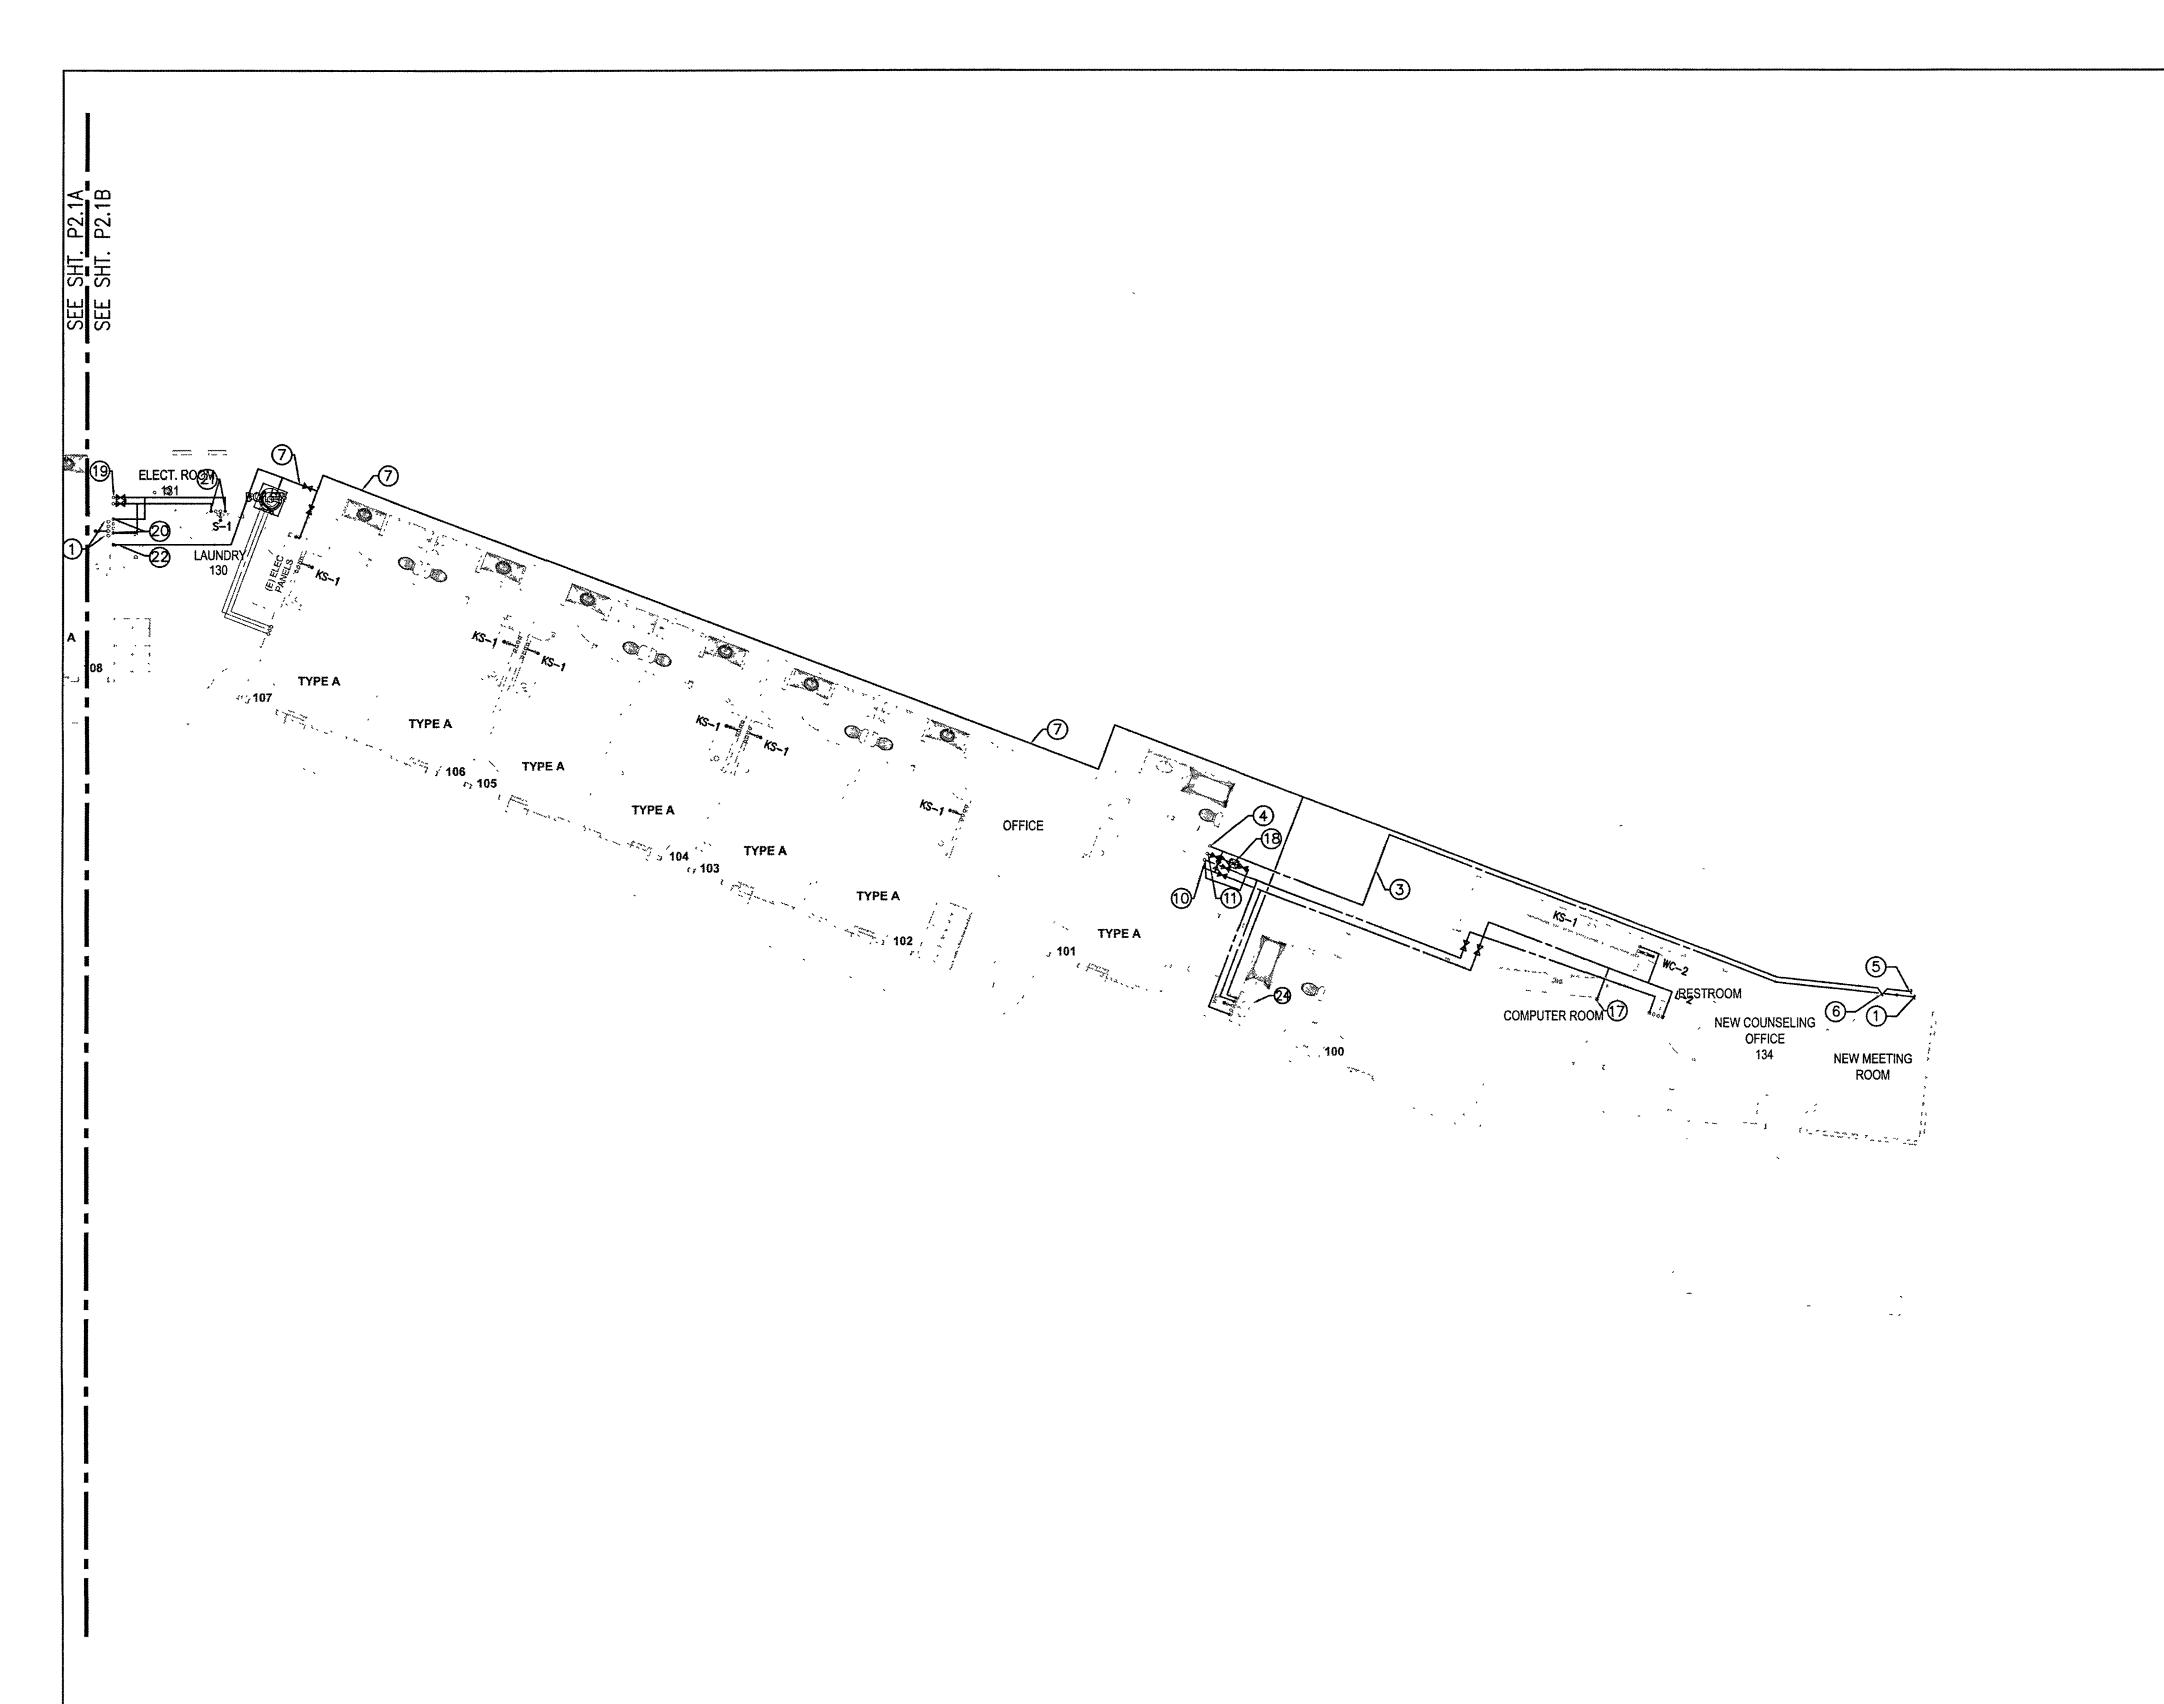
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ISSUE DATES DESCRIPTION DATE 02/28/2023 MEP REVISION SCALE AS SHOWN DRAWN. DATE, 02/28/2023 SHEET TITLE PLUMBING **ENLARGED** PARTIAL FIRST FLOOR WATER &

GAS PLAN SHEET NO:


P2.1A



PLUMBING ENLARGED PARTIAL FIRST FLOOR WATER AND GAS PLAN SCALE: 1/8"=1'-0"

PLUMBING REFERENCE NOTES 1" COLD WATER & CONNECT TO MAIN. VERIFY ON SITE OF EXACT LOCATION OF MAIN WATER LINE. UPSIZE MAIN WATER LINE IF REQUIRED. 1" COLD WATER & 1" HOT WATER SUPPLY © CEILING & DOWN TO SHOWER STALL. REFER TO ARCHITECT & ADA REQUIREMENTS OF EXACT LOCATION OF SHOWER HEAD, VALVES & CONTROLS 2 2-1/2" COLD WATER @ CEILING LEVEL. 1" COLD WATER & 1" HOT WATER SUPPLY @ CEILING & DOWN 3 2-1/2" COLD WATER @ CEILING. KITCHEN SINK. 3/4" HOT WATER TO DISHWASHER. 4 2-1/2" COLD WATER @ CEILING & UP TO SECOND FLOOR 1" COLD WATER & 1" HOT WATER SUPPLY @ CEILING & DOWN CEILING OR ATTIC. TO CLOTHES WASHER. 5 1-1/2" GAS & CONNECT TO MAIN. VERIFY ON SITE OF EXACT LOCATION OF MAIN GAS LINE. UP SIZE MAIN GAS LINE IF REQUIRED. (B) CIRCUIT SOLVER WITH CHECK VALVE AND SHUT-OFF VALVE. 6 1-1/2" GAS & UP TO CEILING LEVEL. (9 1-1/2" COLD WATER & 1-1/2" HOT WATER SUPPLY FROM ⑦ 1-1/2" GAS CEILING. SECOND FLOOR. 1" COLD WATER & 1" HOT WATER SUPPLY @ CEILING & DOWN (9) 1" COLD WATER & 1" HOT WATER SUPPLY FROM ABOVE & DOWN TO KITCHEN SINK. SEE HOT & COLD WATER RISER DIAGRAMS. (TYPICAL) TO CLOTHES WASHER. 1" COLD WATER & 1" HOT WATER SUPPLY @ CEILING & DOWN 1-1/2* HOT WATER SUPPLY @ CEILING & FROM ABOVE. TO HAND SINK. 1" HOT WATER RETURN @ CEILING & FROM SECOND FLOOR. ② 3/4" GAS @ CEILING & DOWN CONNECT TO CLOTHES DRYER. (TYPICAL) 1" COLD WATER @ CEILING & DOWN TO WATER CLOSET. (3) 1" GAS @ CEILING & DOWN CONNECT TO GAS RANGE. 3/4" COLD WATER & 3/4" HOT WATER SUPPLY @ CEILING & (E) LAVATORY TO BE RELOCATE.


DOWN TO LAVATORY.

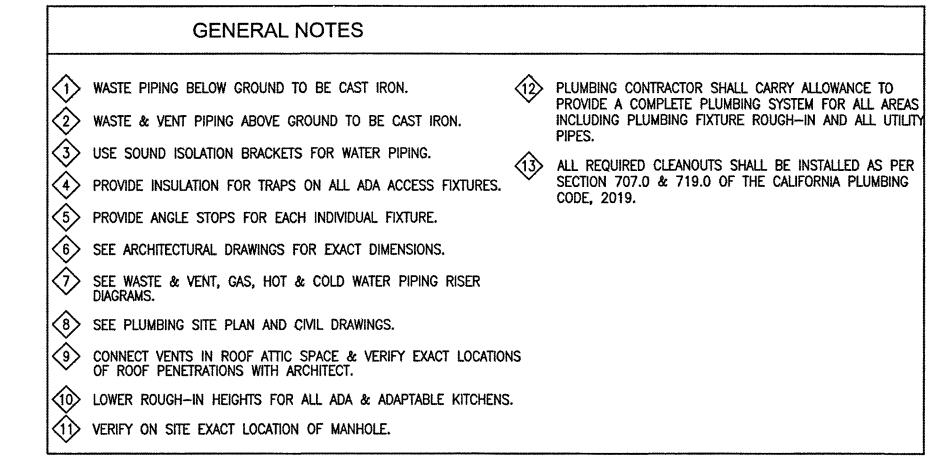


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DESCRIPTION DATE

MEP REVISION 02/28/2023

JOB'
SCALE AS SHOWN

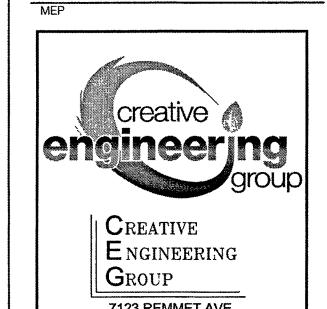DRAWN: CEG

DATE: 02/28/2023

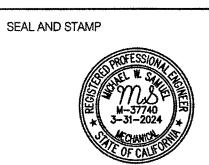SHEET TITLE:

PLUMBING


ENLARGED

PARTIAL FIRST

FLOOR WATER & GAS PLAN

SHEET NO.

P2.1B

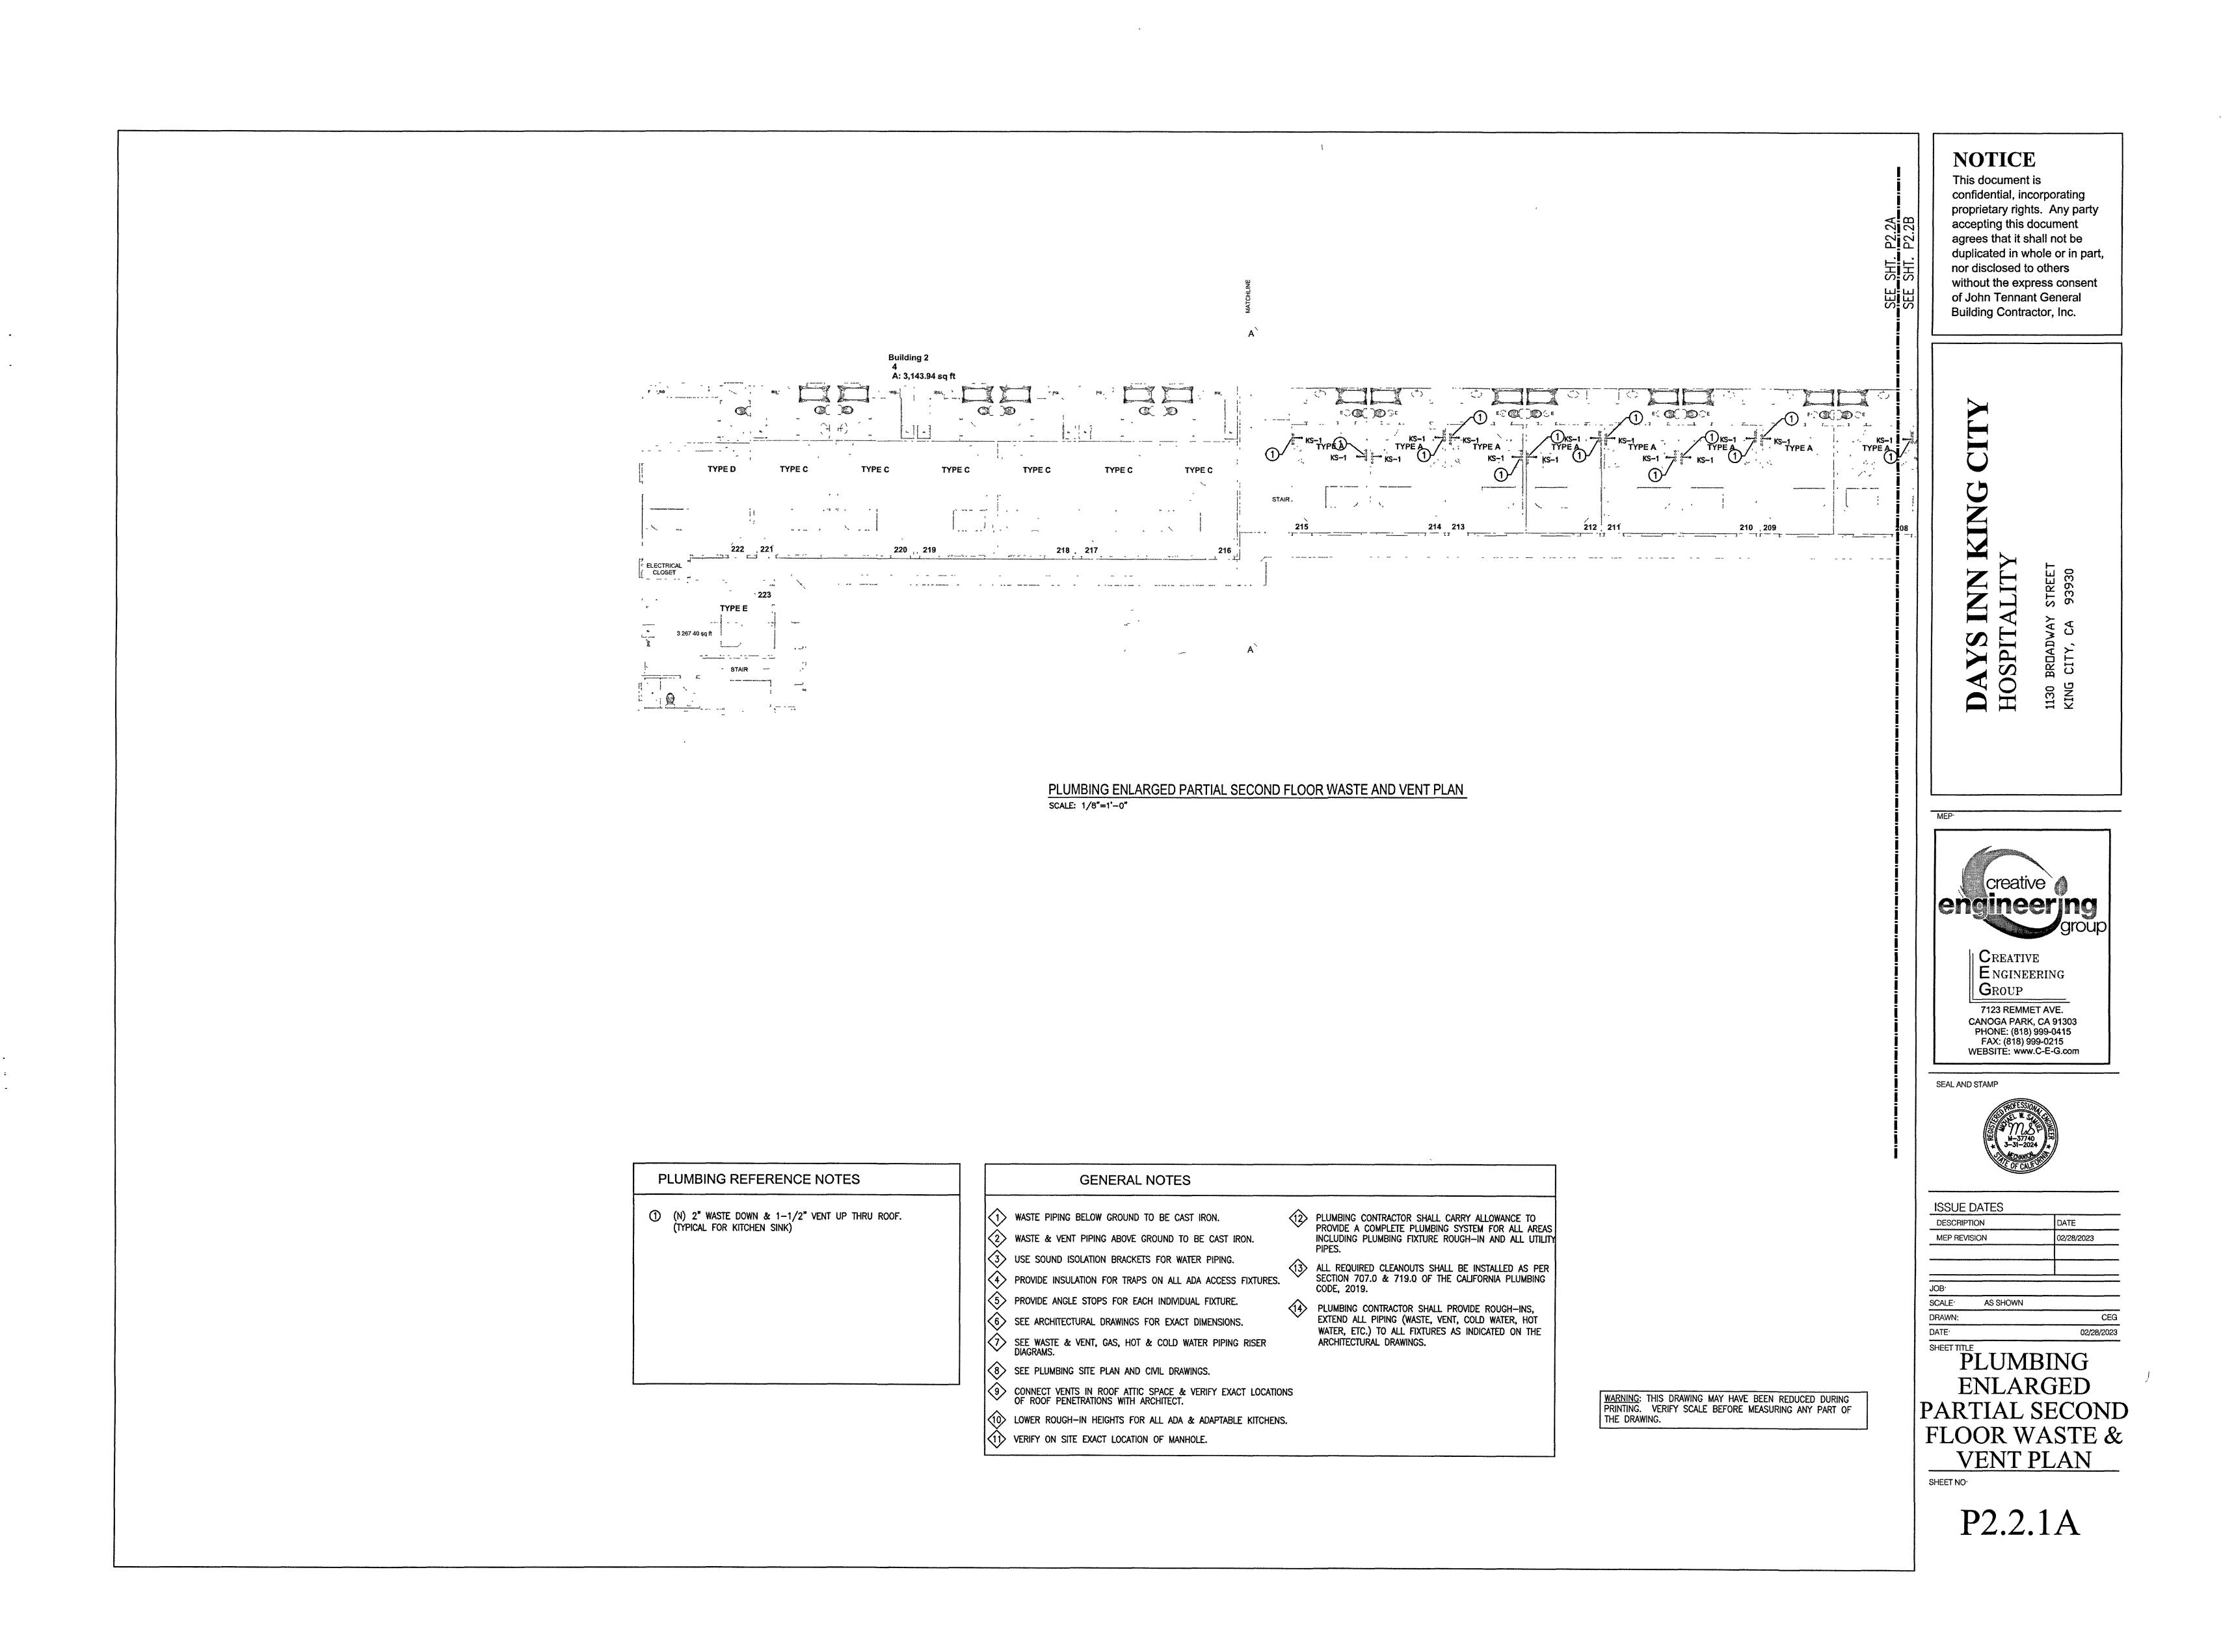

Building 1 3 A: 5,130.85 sq ft PLUMBING ENLARGED PARTIAL SECOND FLOOR WASTE AND VENT PLAN SCALE: 1/8"=1'-0"



- (1) (N) 2" WASTE DOWN & 1-1/2" VENT UP THRU ROOF. (TYPICAL FOR KITCHEN SINK)
- ② (N) 1-1/2" VENT UP THRU ROOF.
- (N) 2" VENT UP THRU ROOF.

GENERAL NOTES

- (1) WASTE PIPING BELOW GROUND TO BE CAST IRON.
- 2 WASTE & VENT PIPING ABOVE GROUND TO BE CAST IRON.

PLUMBING CONTRACTOR SHALL CARRY ALLOWANCE TO PROVIDE A COMPLETE PLUMBING SYSTEM FOR ALL AREAS INCLUDING PLUMBING FIXTURE ROUGH—IN AND ALL UTILITY PIPES.

ALL REQUIRED CLEANOUTS SHALL BE INSTALLED AS PER SECTION 707.0 & 719.0 OF THE CALIFORNIA PLUMBING CODE, 2019.

PLUMBING CONTRACTOR SHALL PROVIDE ROUGH—INS, EXTEND ALL PIPING (WASTE, VENT, COLD WATER, HOT WATER, ETC.) TO ALL FIXTURES AS INDICATED ON THE


ARCHITECTURAL DRAWINGS.


- 3 USE SOUND ISOLATION BRACKETS FOR WATER PIPING. PROVIDE INSULATION FOR TRAPS ON ALL ADA ACCESS FIXTURES.
- 5 PROVIDE ANGLE STOPS FOR EACH INDIVIDUAL FIXTURE.
- (6) SEE ARCHITECTURAL DRAWINGS FOR EXACT DIMENSIONS.
- SEE WASTE & VENT, GAS, HOT & COLD WATER PIPING RISER DIAGRAMS.
- 8 SEE PLUMBING SITE PLAN AND CIVIL DRAWINGS.
- 9 CONNECT VENTS IN ROOF ATTIC SPACE & VERIFY EXACT LOCATIONS OF ROOF PENETRATIONS WITH ARCHITECT.
- LOWER ROUGH-IN HEIGHTS FOR ALL ADA & ADAPTABLE KITCHENS.
- VERIFY ON SITE EXACT LOCATION OF MANHOLE.

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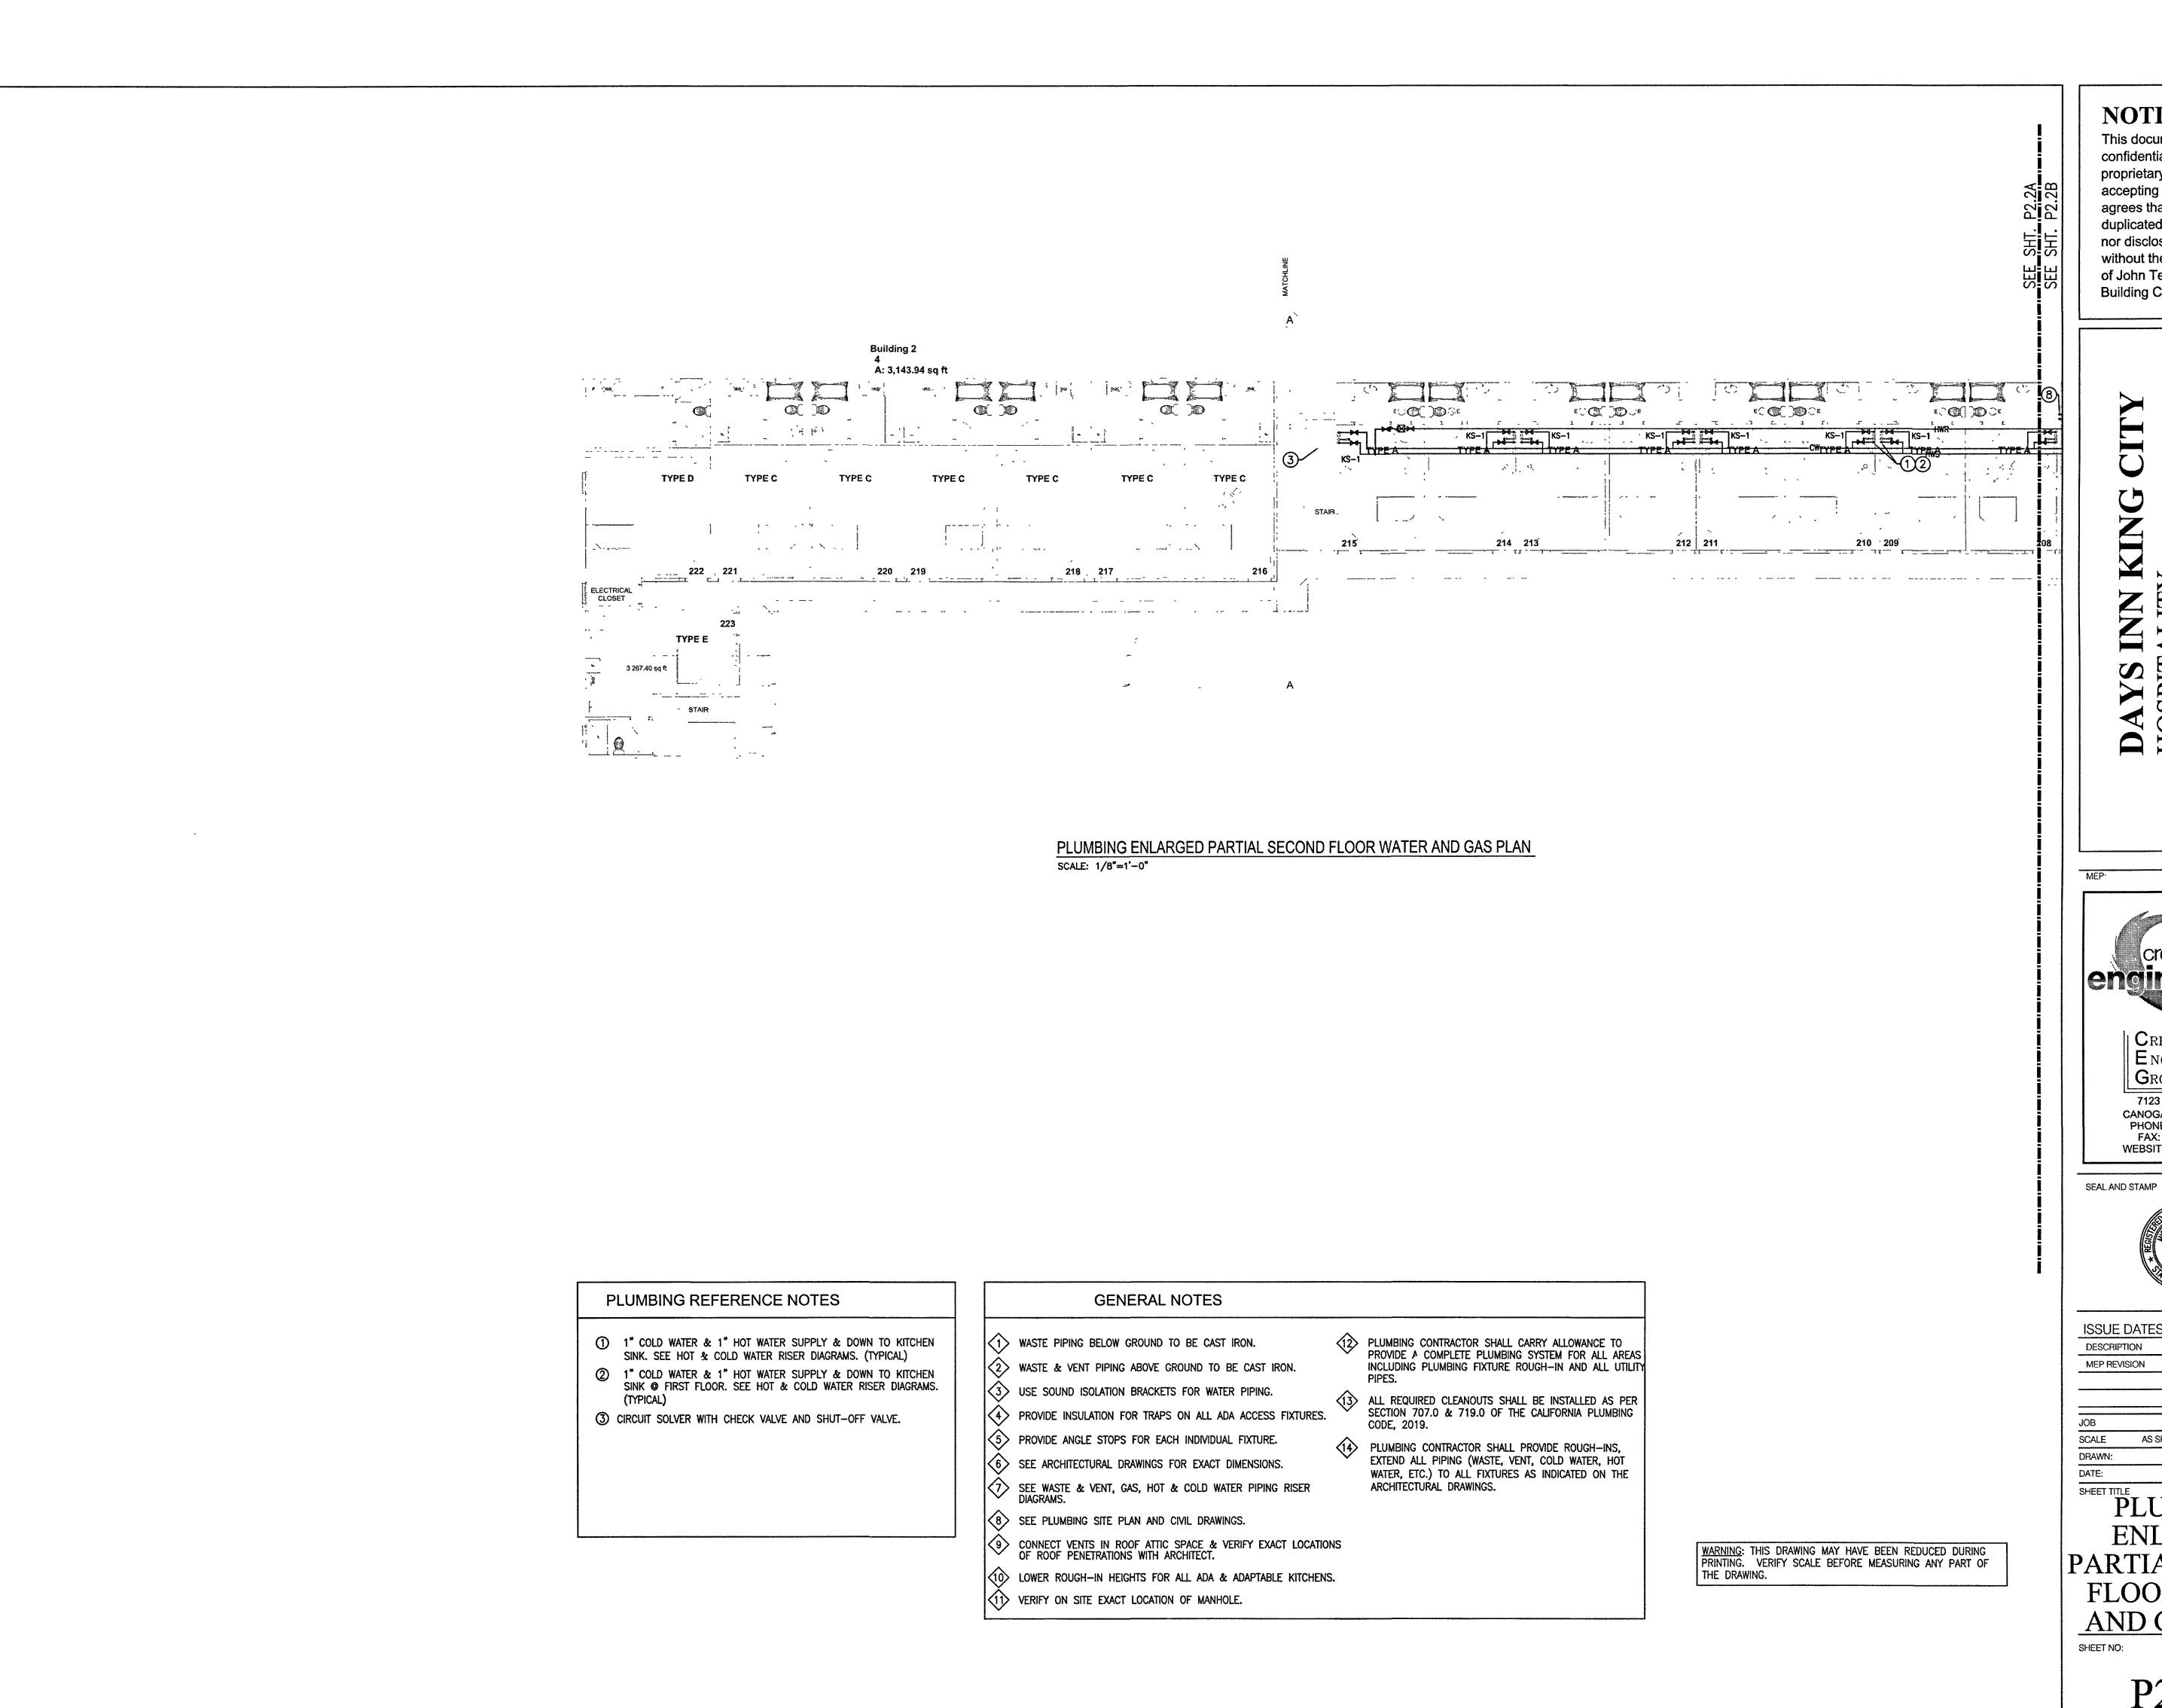




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DRAWN: 02/28/2023

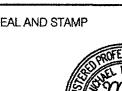SHEET TITLE
PLUMBING **ENLARGED** PARTIAL SECOND FLOOR WASTE & VENT PLAN SHEET NO

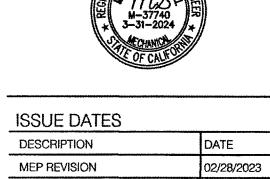
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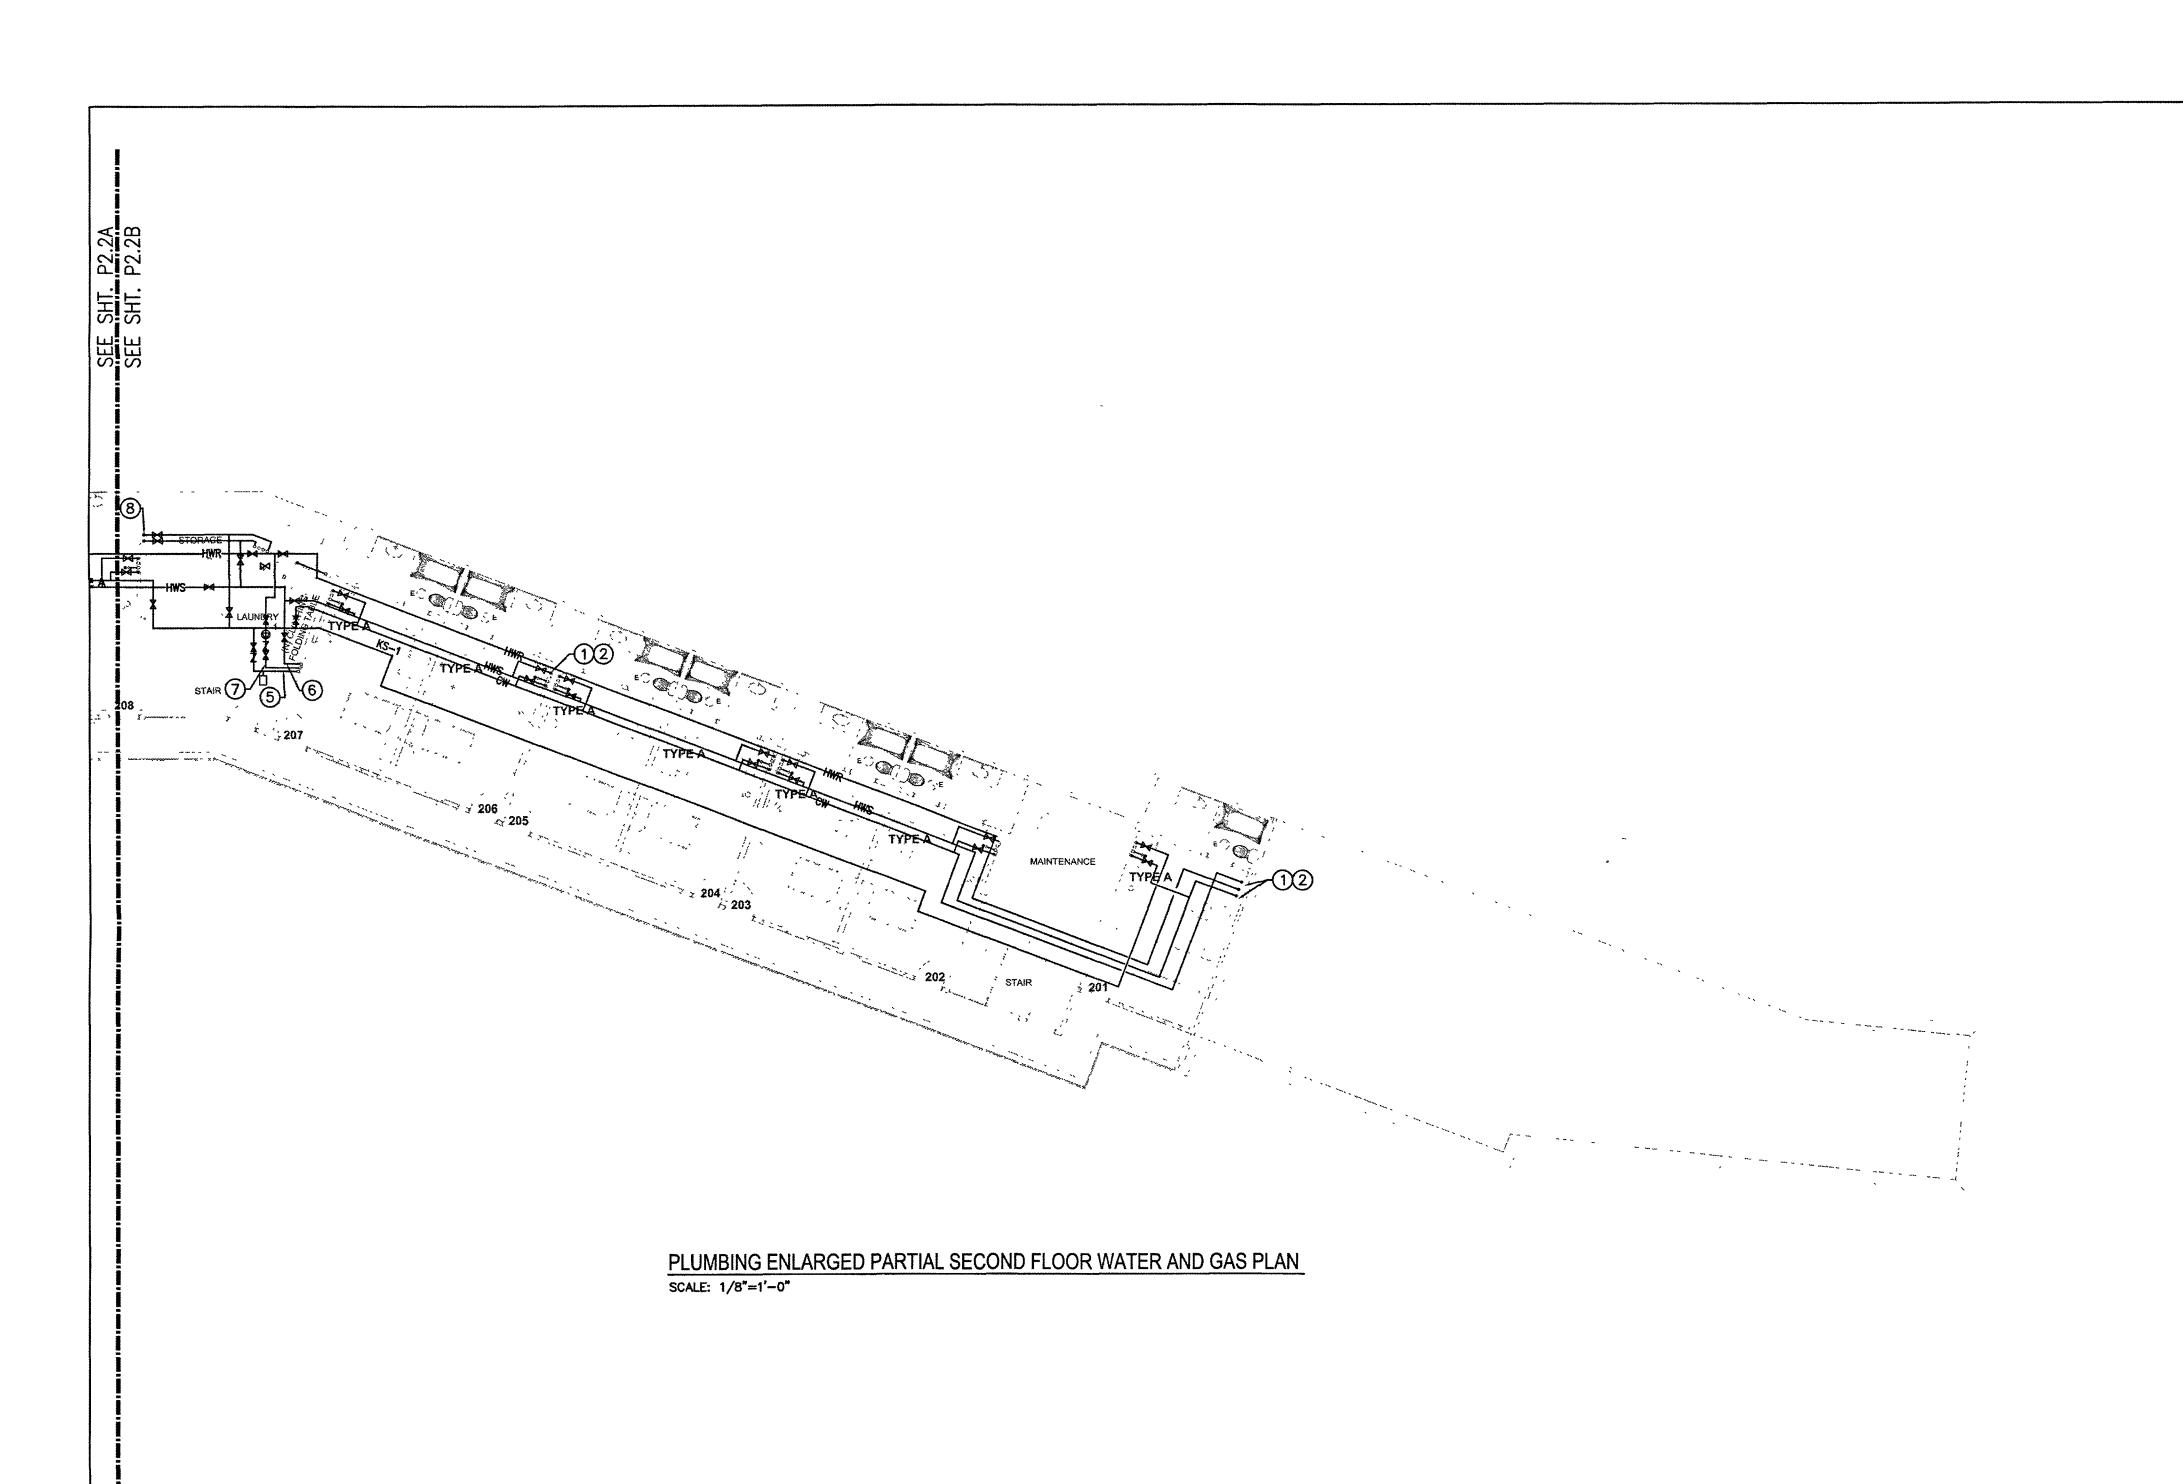




ISSUE DATES 02/28/2023 AS SHOWN 02/28/2023 SHEET TITLE
PLUMBING **ENLARGED**

PARTIAL SECOND FLOOR WATER AND GAS PLAN

P2.2A

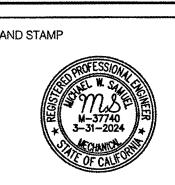

PLUMBING REFERENCE NOTES

- 1" COLD WATER & 1" HOT WATER SUPPLY & DOWN TO KITCHEN SINK. SEE HOT & COLD WATER RISER DIAGRAMS. (TYPICAL)
- 2 1" COLD WATER & 1" HOT WATER SUPPLY & DOWN TO KITCHEN SINK @ FIRST FLOOR. SEE HOT & COLD WATER RISER DIAGRAMS.
- 3 1-1/4" GAS FROM BELOW & UP TO CEILING.
- 4 1-1/4" GAS & DOWN TO WATER HEATER.
- 6 2-1/2" HOT WATER SUPPLY FROM WATER HEATER & UP TO CEILING.
- 8 1-1/2" COLD WATER & 1-1/2" HOT WATER SUPPLY & DOWN TO FIRST FLOOR LAUNDRY ROOM.

GENERAL NOTES

- (1) WASTE PIPING BELOW GROUND TO BE CAST IRON. 2 WASTE & VENT PIPING ABOVE GROUND TO BE CAST IRON.
- 3 USE SOUND ISOLATION BRACKETS FOR WATER PIPING.

PLUMBING CONTRACTOR SHALL CARRY ALLOWANCE TO PROVIDE A COMPLETE PLUMBING SYSTEM FOR ALL AREAS INCLUDING PLUMBING FIXTURE ROUGH—IN AND ALL UTILITY

ALL REQUIRED CLEANOUTS SHALL BE INSTALLED AS PER SECTION 707.0 & 719.0 OF THE CALIFORNIA PLUMBING CODE, 2019.

PLUMBING CONTRACTOR SHALL PROVIDE ROUGH-INS, EXTEND ALL PIPING (WASTE, VENT, COLD WATER, HOT

WATER, ETC.) TO ALL FIXTURES AS INDICATED ON THE ARCHITECTURAL DRAWINGS.

- 4> PROVIDE INSULATION FOR TRAPS ON ALL ADA ACCESS FIXTURES. 5> PROVIDE ANGLE STOPS FOR EACH INDIVIDUAL FIXTURE.
- (6) SEE ARCHITECTURAL DRAWINGS FOR EXACT DIMENSIONS.
- SEE WASTE & VENT, GAS, HOT & COLD WATER PIPING RISER DIAGRAMS.
- 8 SEE PLUMBING SITE PLAN AND CIVIL DRAWINGS.

(1) VERIFY ON SITE EXACT LOCATION OF MANHOLE.

- © CONNECT VENTS IN ROOF ATTIC SPACE & VERIFY EXACT LOCATIONS OF ROOF PENETRATIONS WITH ARCHITECT.
- LOWER ROUGH-IN HEIGHTS FOR ALL ADA & ADAPTABLE KITCHENS.


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ISSUE DATES

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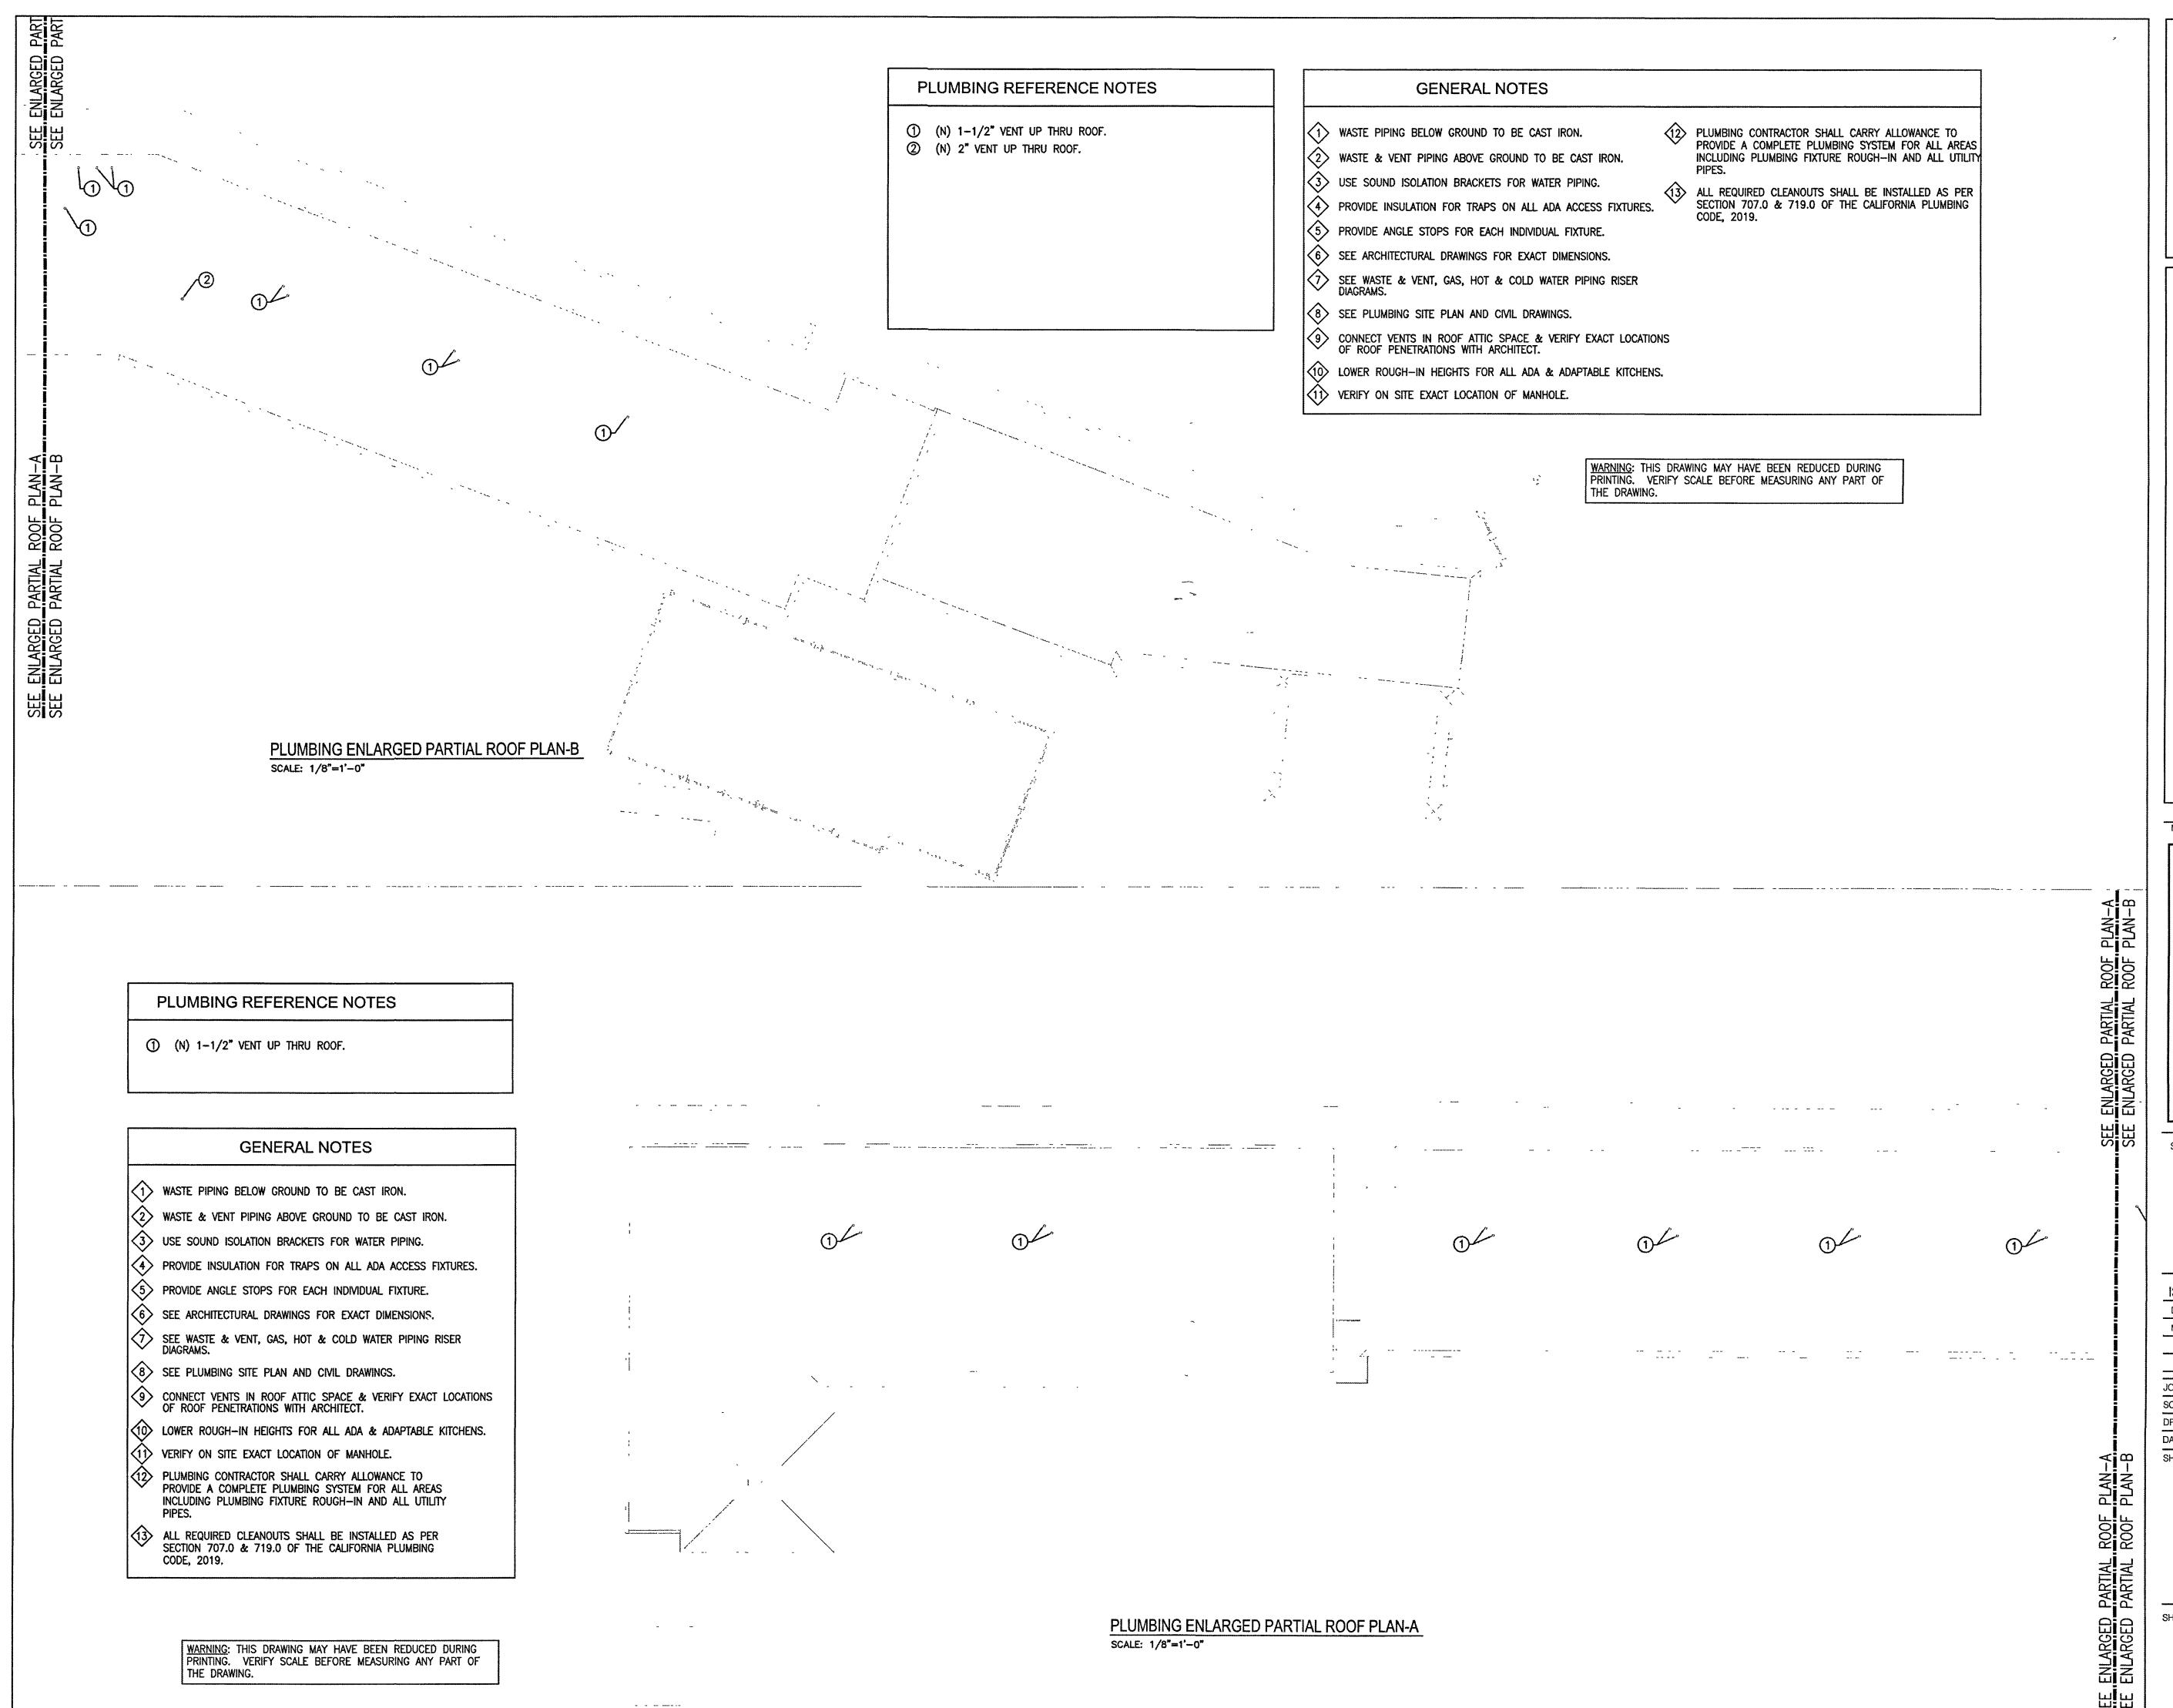


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P2.2B



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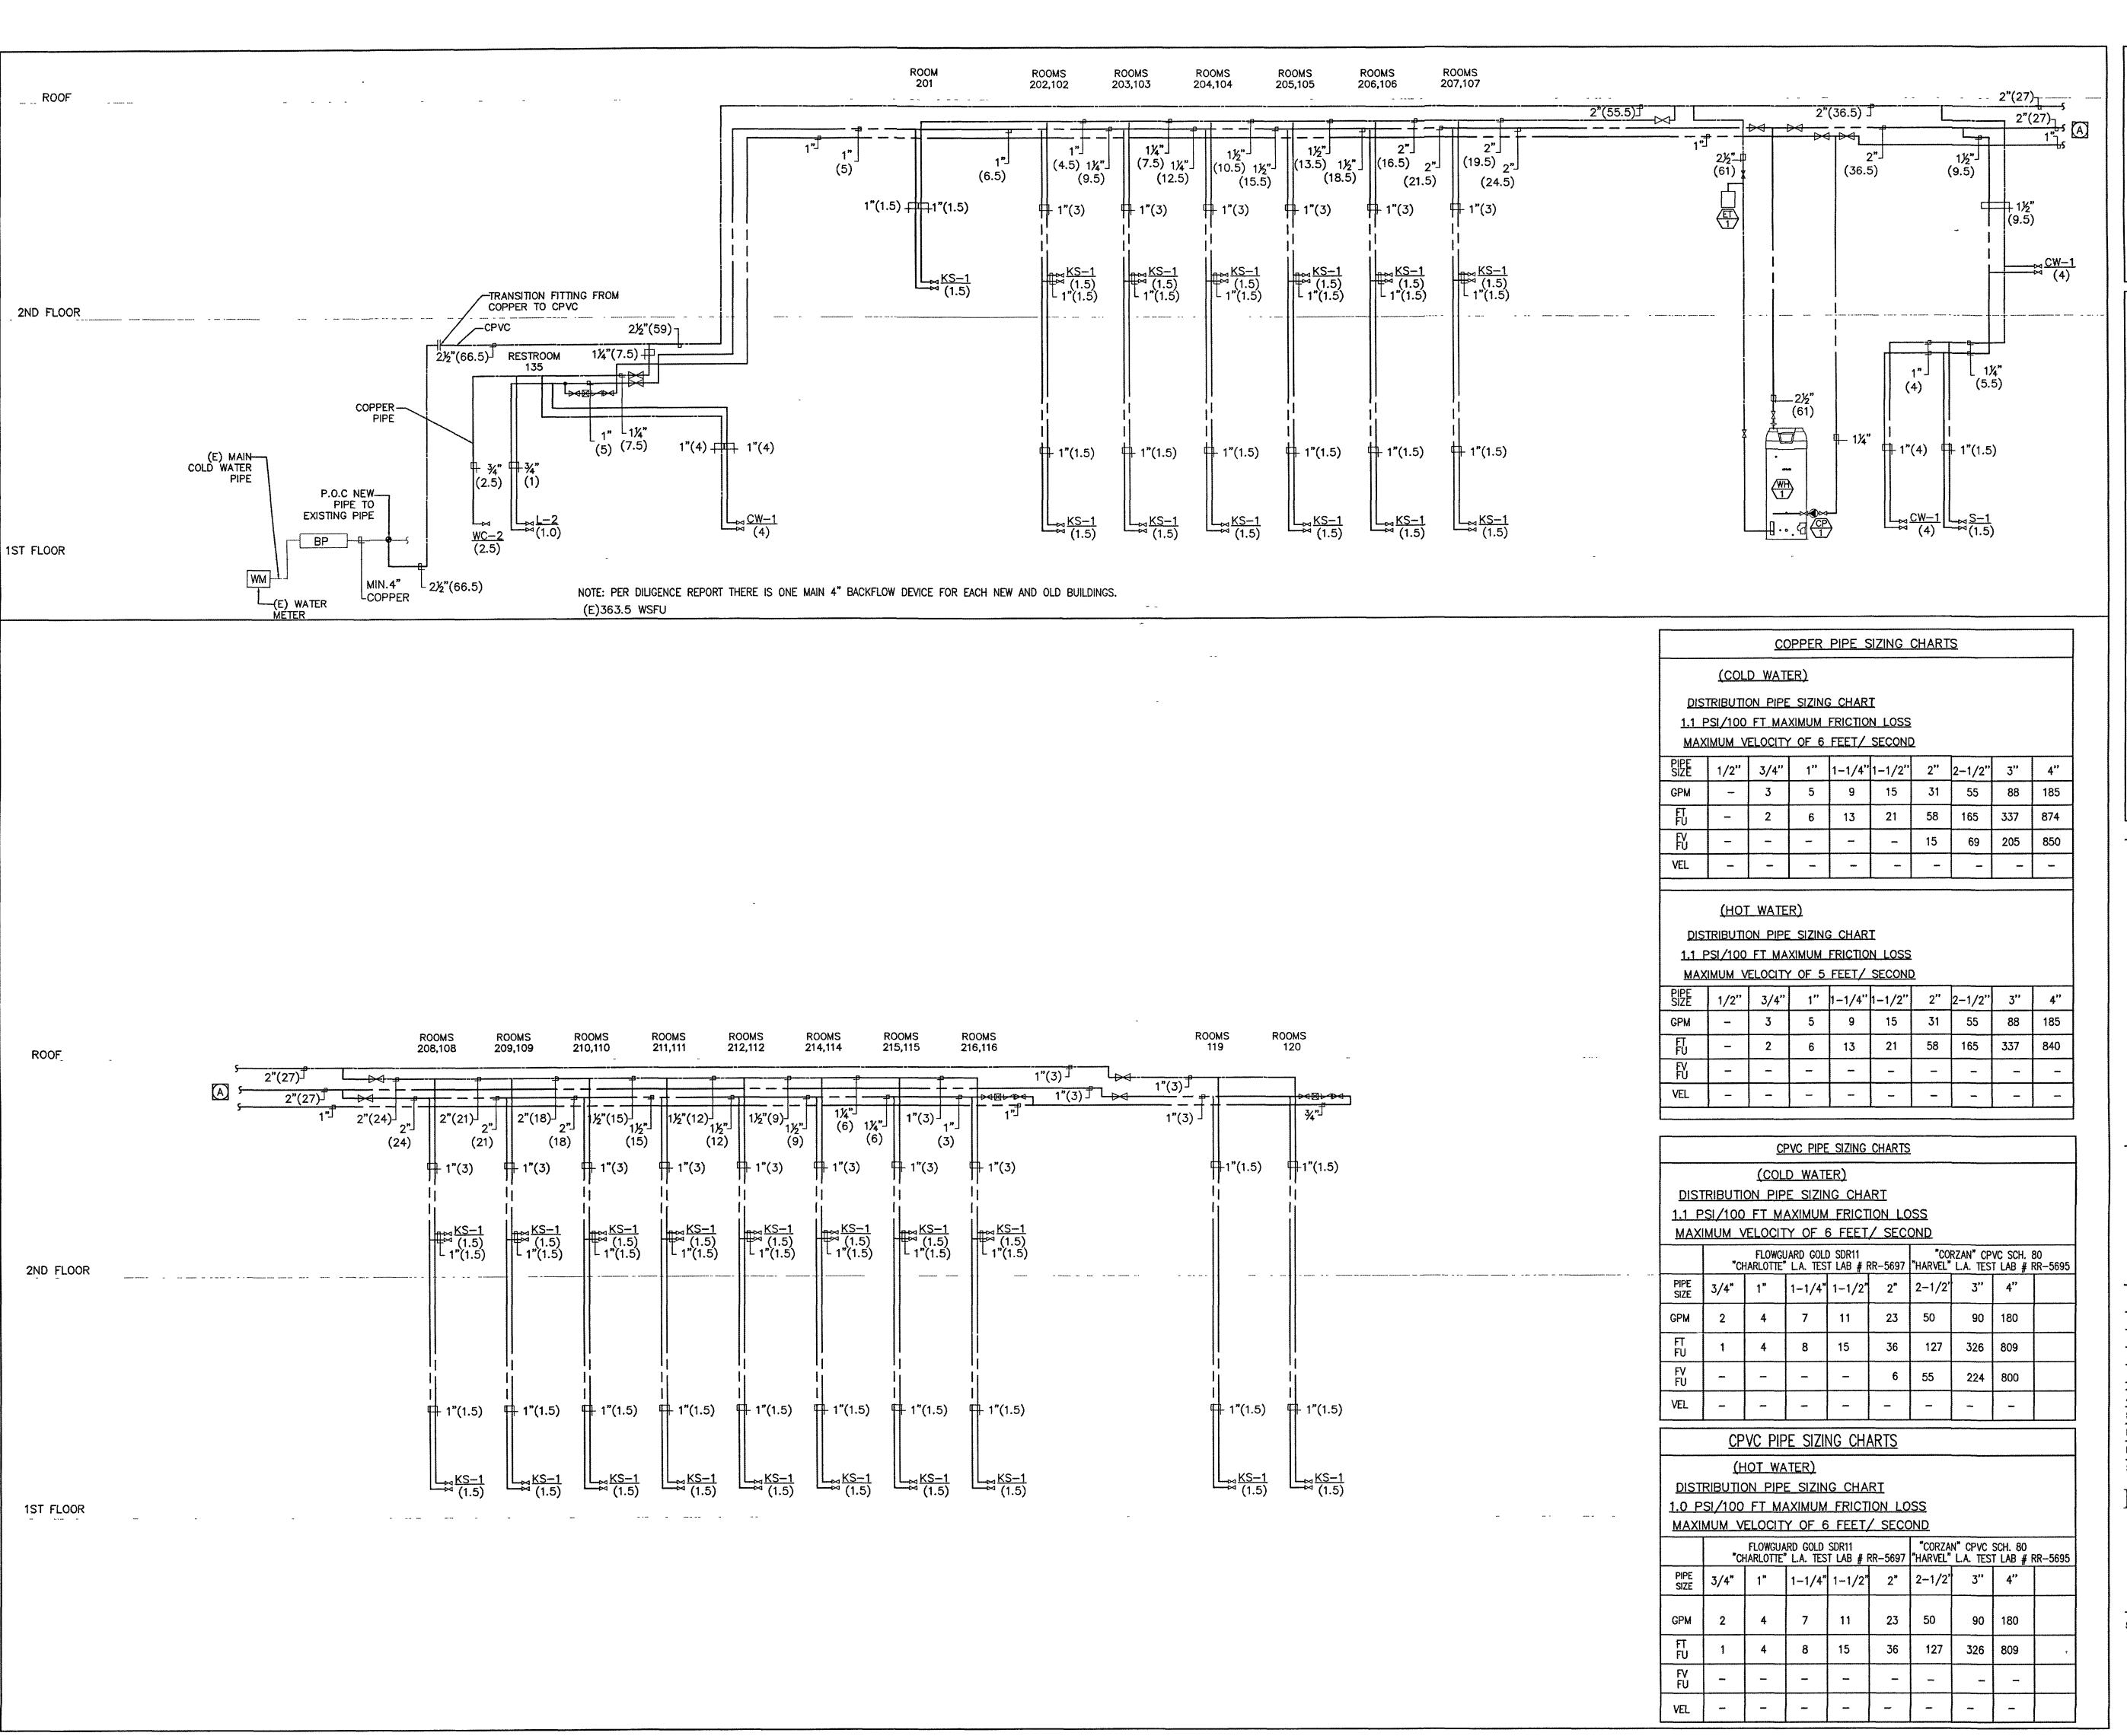
| CREATIVE ENGINEERING GROUP 7123 REMMET AVE.
CANOGA PARK, CA 91303
PHONE: (818) 999-0415
FAX: (818) 999-0215
WEBSITE: www.C-E-G.com

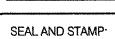SEAL AND STAMP

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PLUMBING ROOF PLAN

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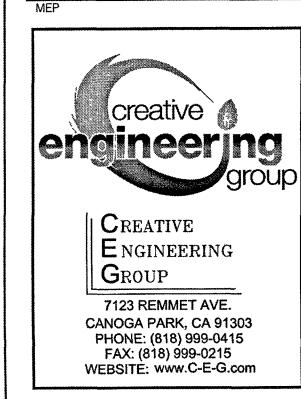



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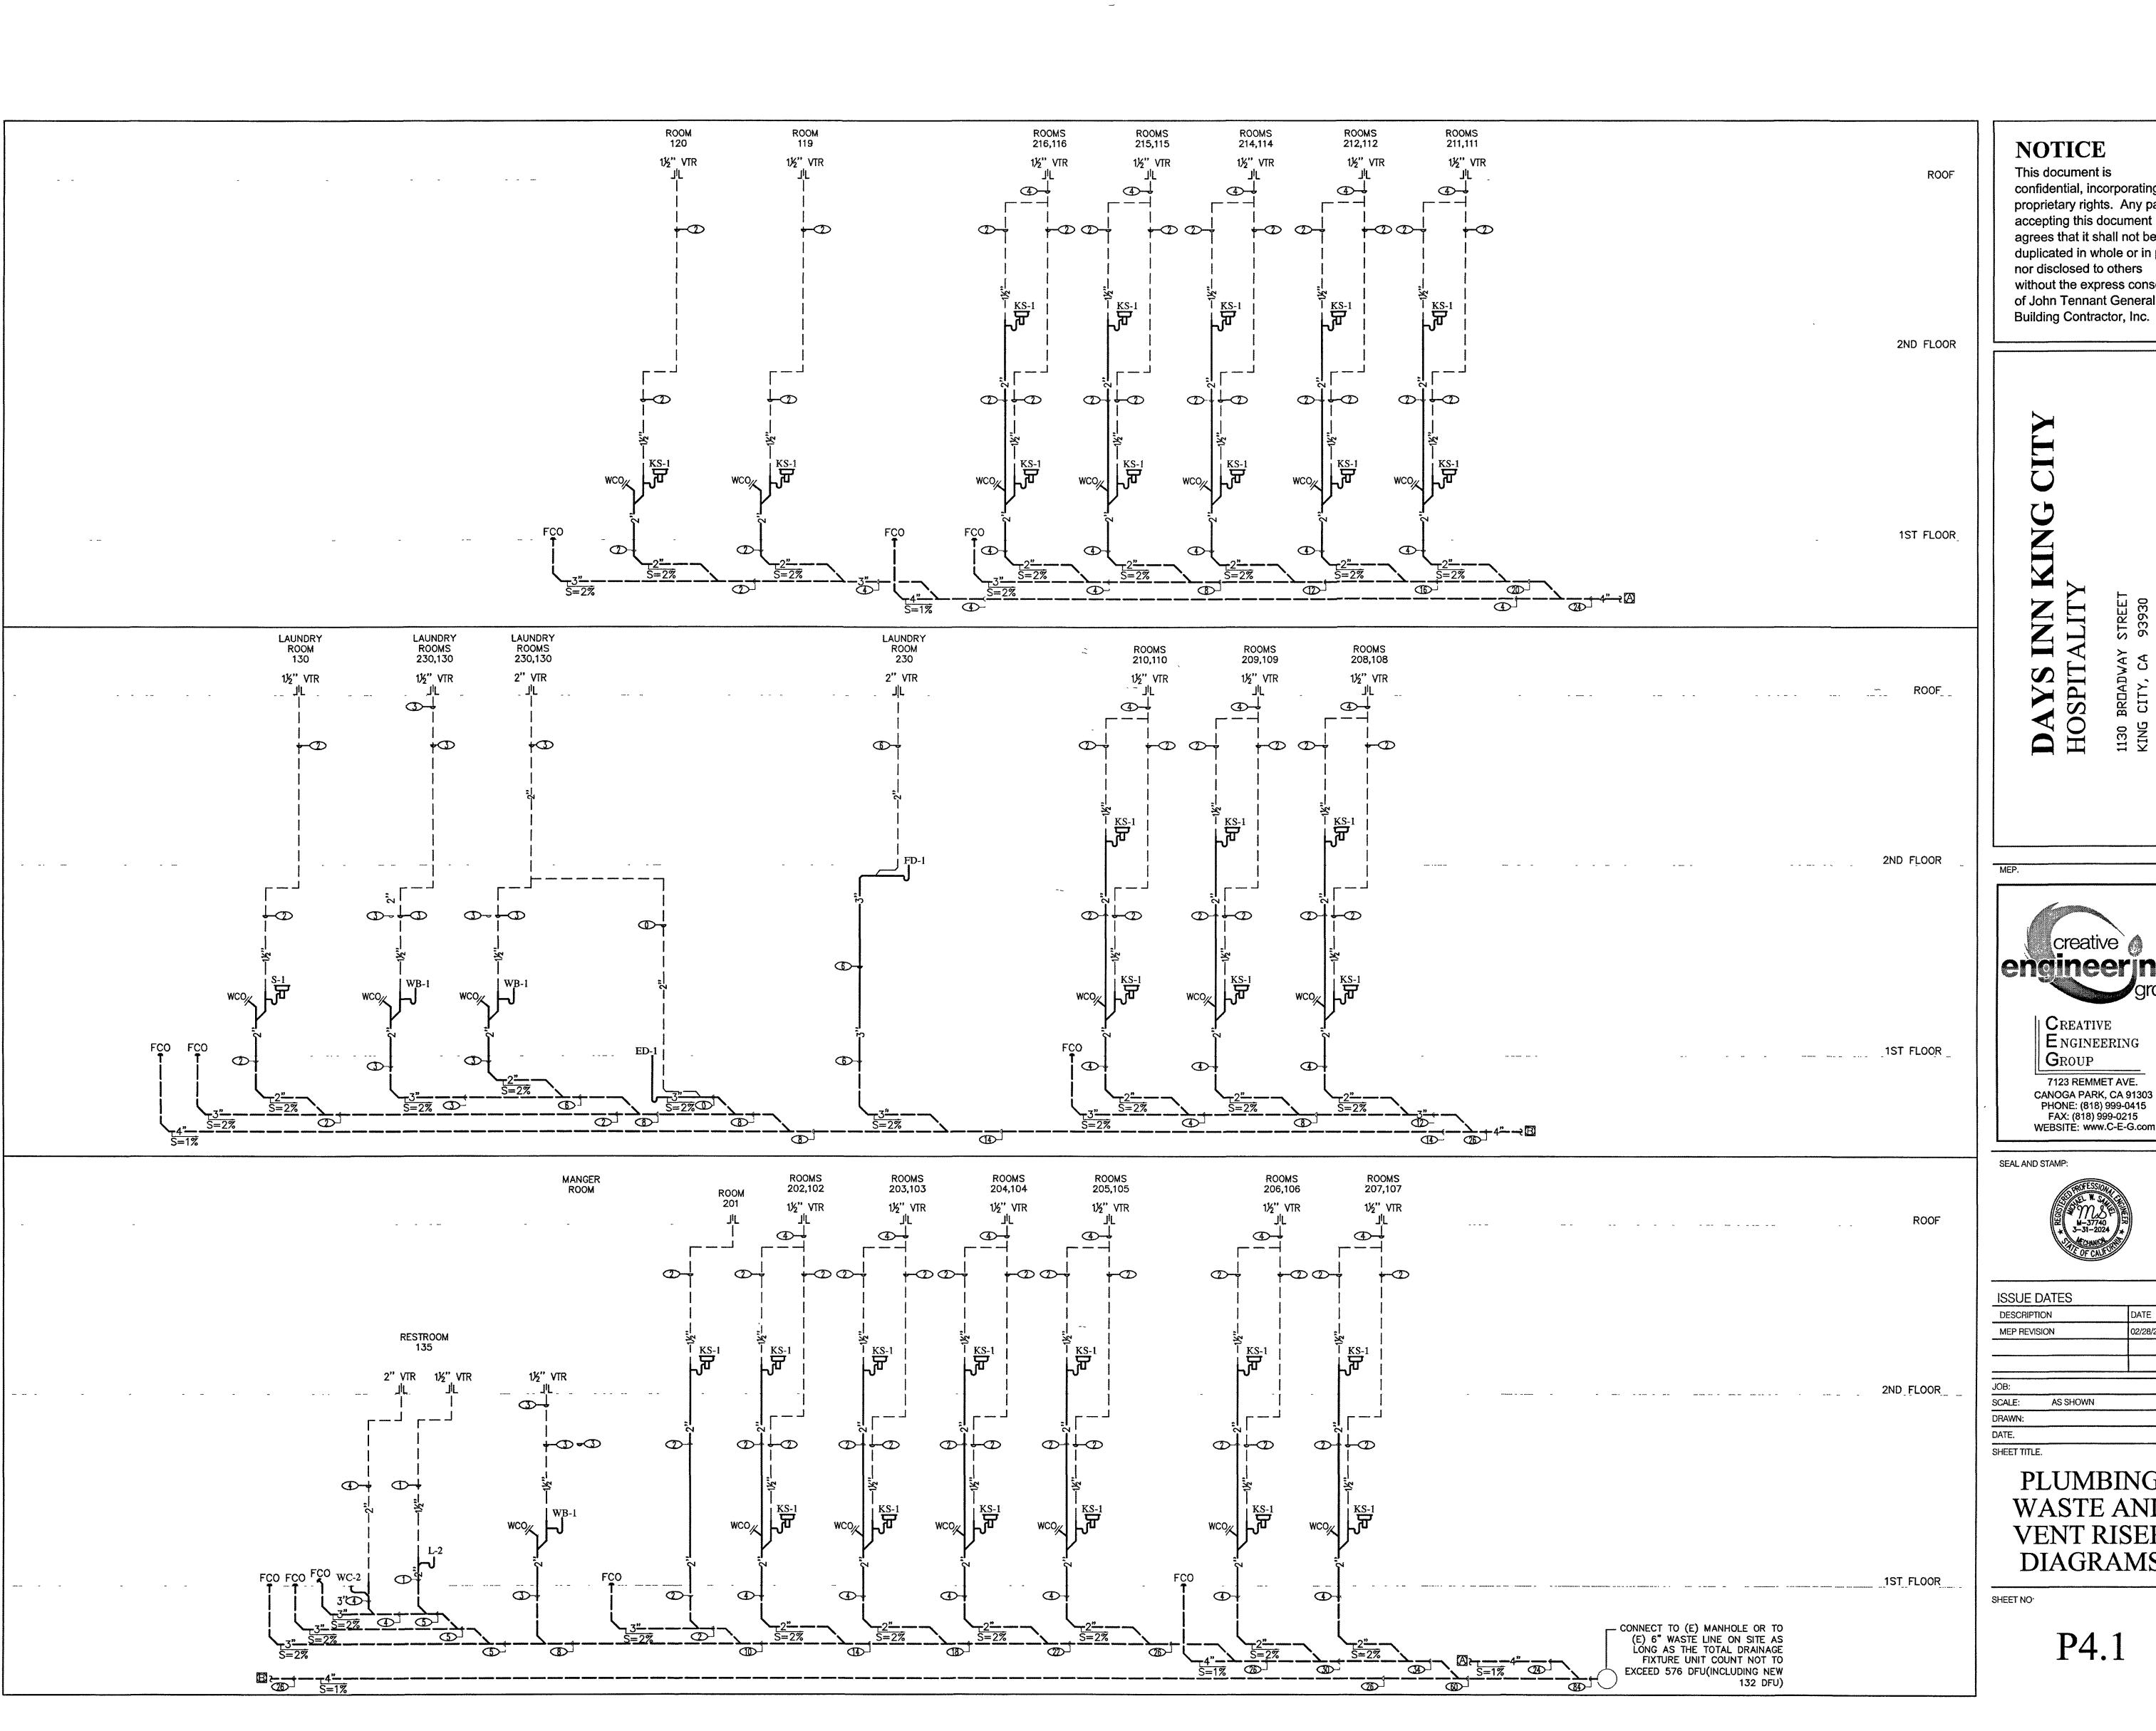


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PLUMBING HOT AND COLD WATER RISER DIAGRAMS

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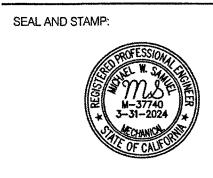
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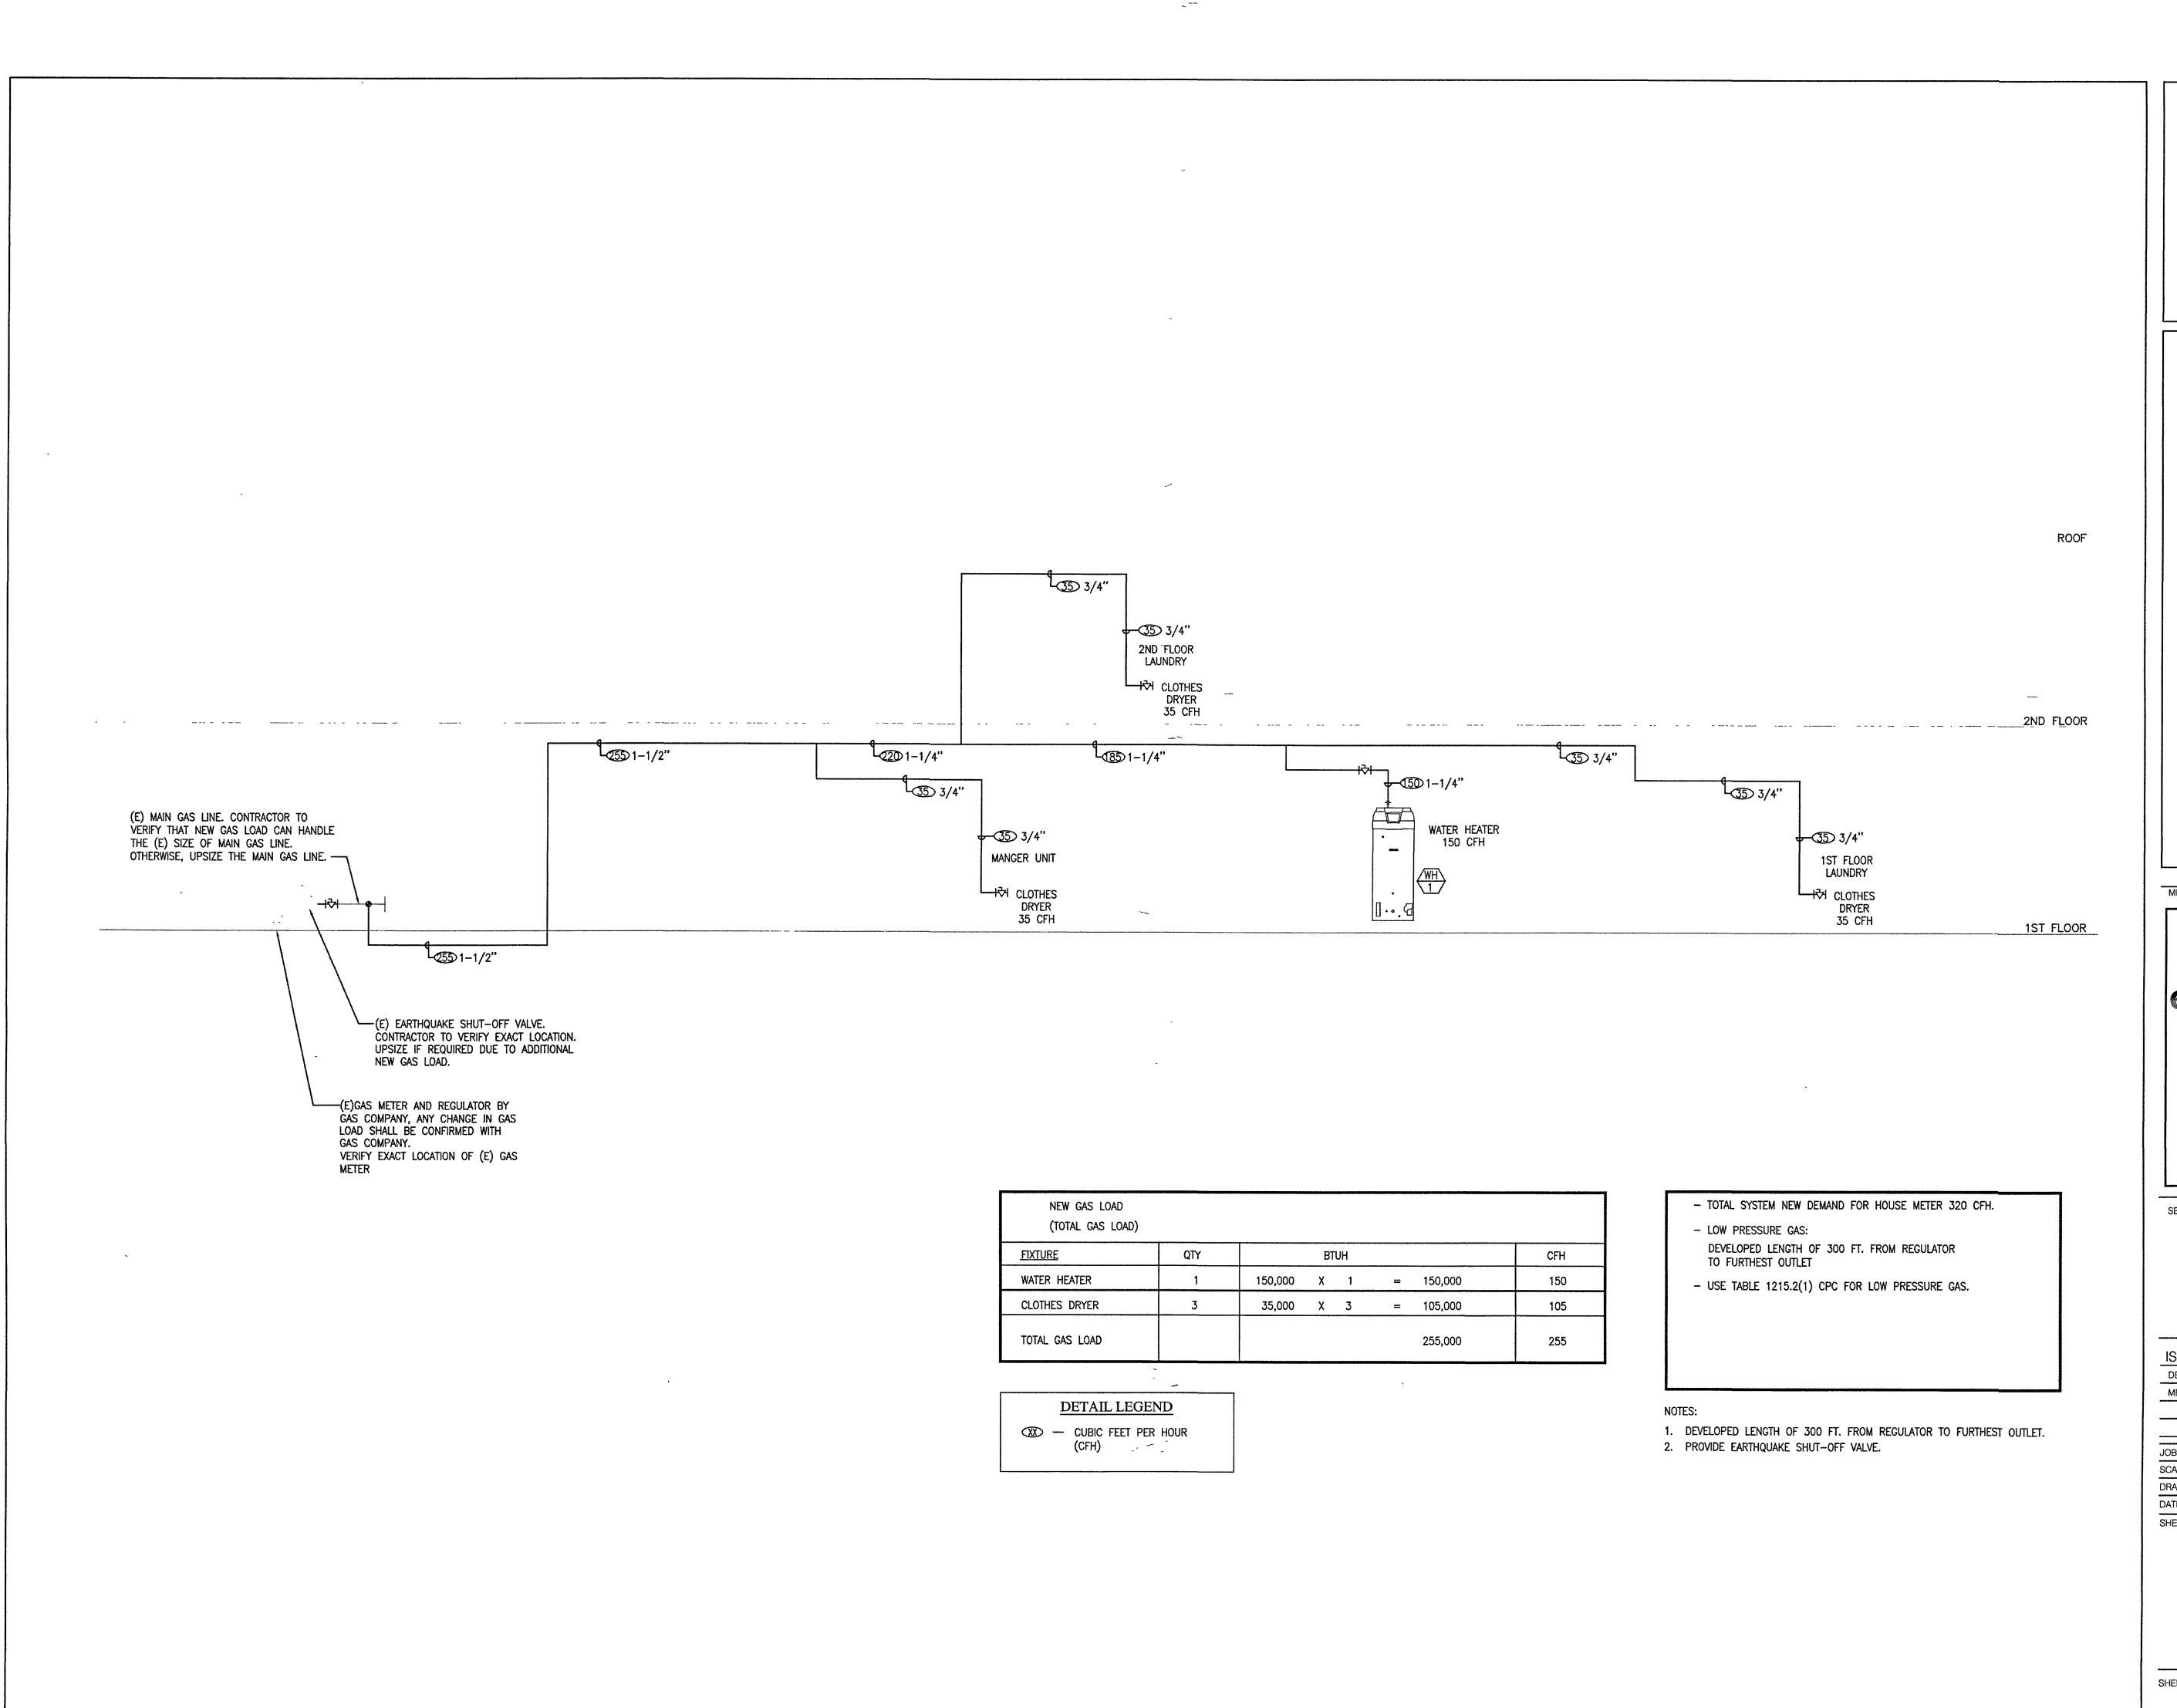




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PLUMBING WASTE AND VENT RISER **DIAGRAMS**
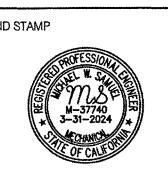
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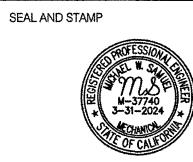
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PLUMBING GAS RISER DIAGRAMS

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